

geo - logic geotechnical and environmental consulting services

1140 - 5th Avenue, Crockett, CA 94525

(510) 787-6867 - Fax (510) 787-1457

FACSIMILE TRANSMITTAL

DATE: 1/13/04

of Pages (including cover page) 4

TO: Mr. Rob Weston - Alameda Co.

FAX NO: 510 337-9335

FROM: Joel Greger 510 593-5382 cell phone

RE: 2421 Blanding Avenue, Alameda

Rob - here is the soil and grab water analytical data for this site summarized in table form. After your review, can you please call me to discuss the next course of action for this site.

TABLE 1
SOIL ANALYTICAL RESULTS
Allied Engineering and Production Co.
2421 Blanding Avenue, Alameda, CA

Samples collected on 1/7/04

Sample/ Depth (feet)	TPH-g (ppm)	Benzene (ppm)	Ethylbenzene (ppm)	Toluene (ppm)	Xylenes (ppm)	MTBE (ppm)	Lead (ppm)
TP-W (7.25')	6400	6.4	7.4	<1.0	8.6	<0.10*	33
TP-N (8')	320	0.41	0.81	<0.050	0.31	<0.25*	7.2
PI (3.5')	68	0.60	0.81	3.3	3.4	<0.033*	11
Disp. (3.5')	1700	3.4	19	0.60	4.5	<0.10*	19
Comp S1	560	2.1	2.2	0.41	4.4	<1.0**	40

EXPLANATION:

ppm = parts per million

NA = Not analyzed

* The eight fuel oxygenates by EPA Method 8260 were non-detectable, see laboratory sheets.


** by EPA Method 8021B.

ANALYTICAL METHODS:

TPHg = Total Petroleum Hydrocarbons as gasoline by EPA Method 8015-Modified.

BTEX = Benzene, Toluene, Ethylbenzene, and Xylenes according to EPA Method 8020.

MTBE = methyl tert-butyl ether according to EPA Method 8260 except as shown (Comp S1).

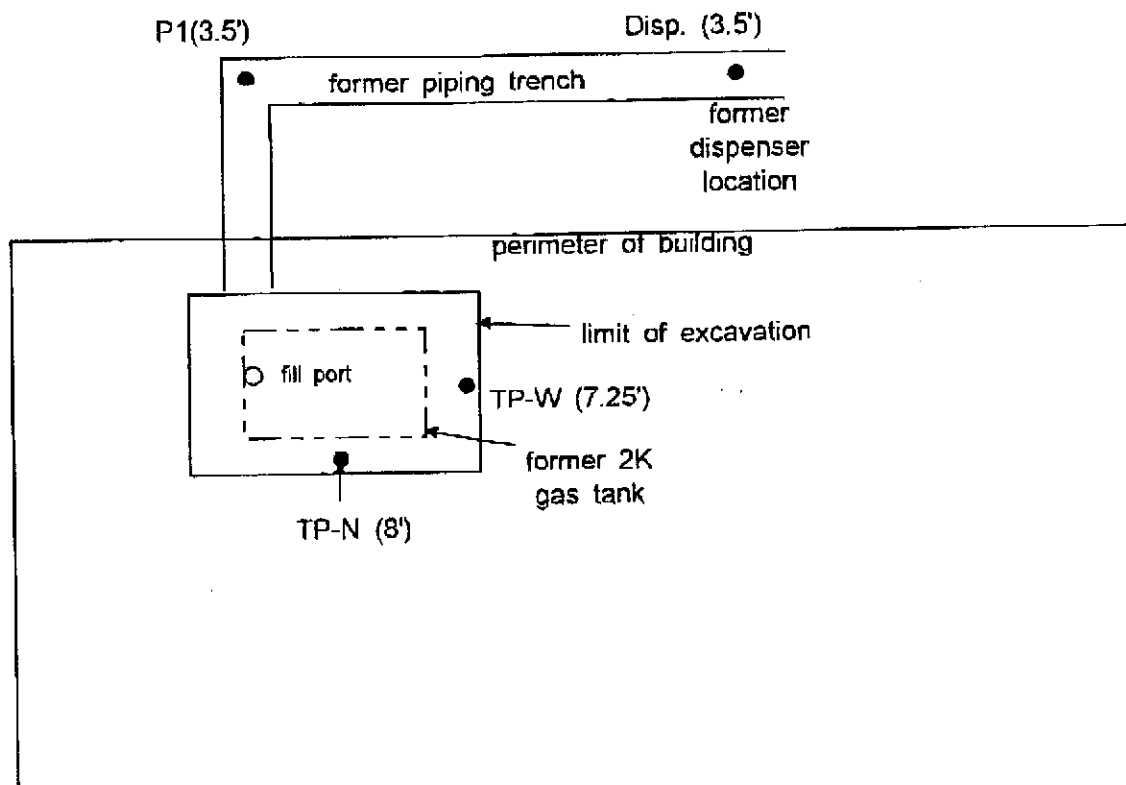

LEGEND

- soil sample (depth)
samples collected on 1/7/04

SCALE: 1" = 10'

Allied Engineering & Production Co. 2421 Blanding Avenue Alameda, California	Figure No: 1	Date: January 7, 2004
		Drawn By: JG/Geo-Logic

Site Plan