




VICINITY MAP

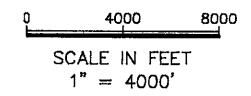


			SCALE: AS SHOWN	
			DESIGNED BY: CEM	
			DRAWN BY: JEB	
			CHECKED BY: 704	
			DATE: 9/6/9/	
			APPROVED BY:	
	REVISIONS	BY	DATE:	

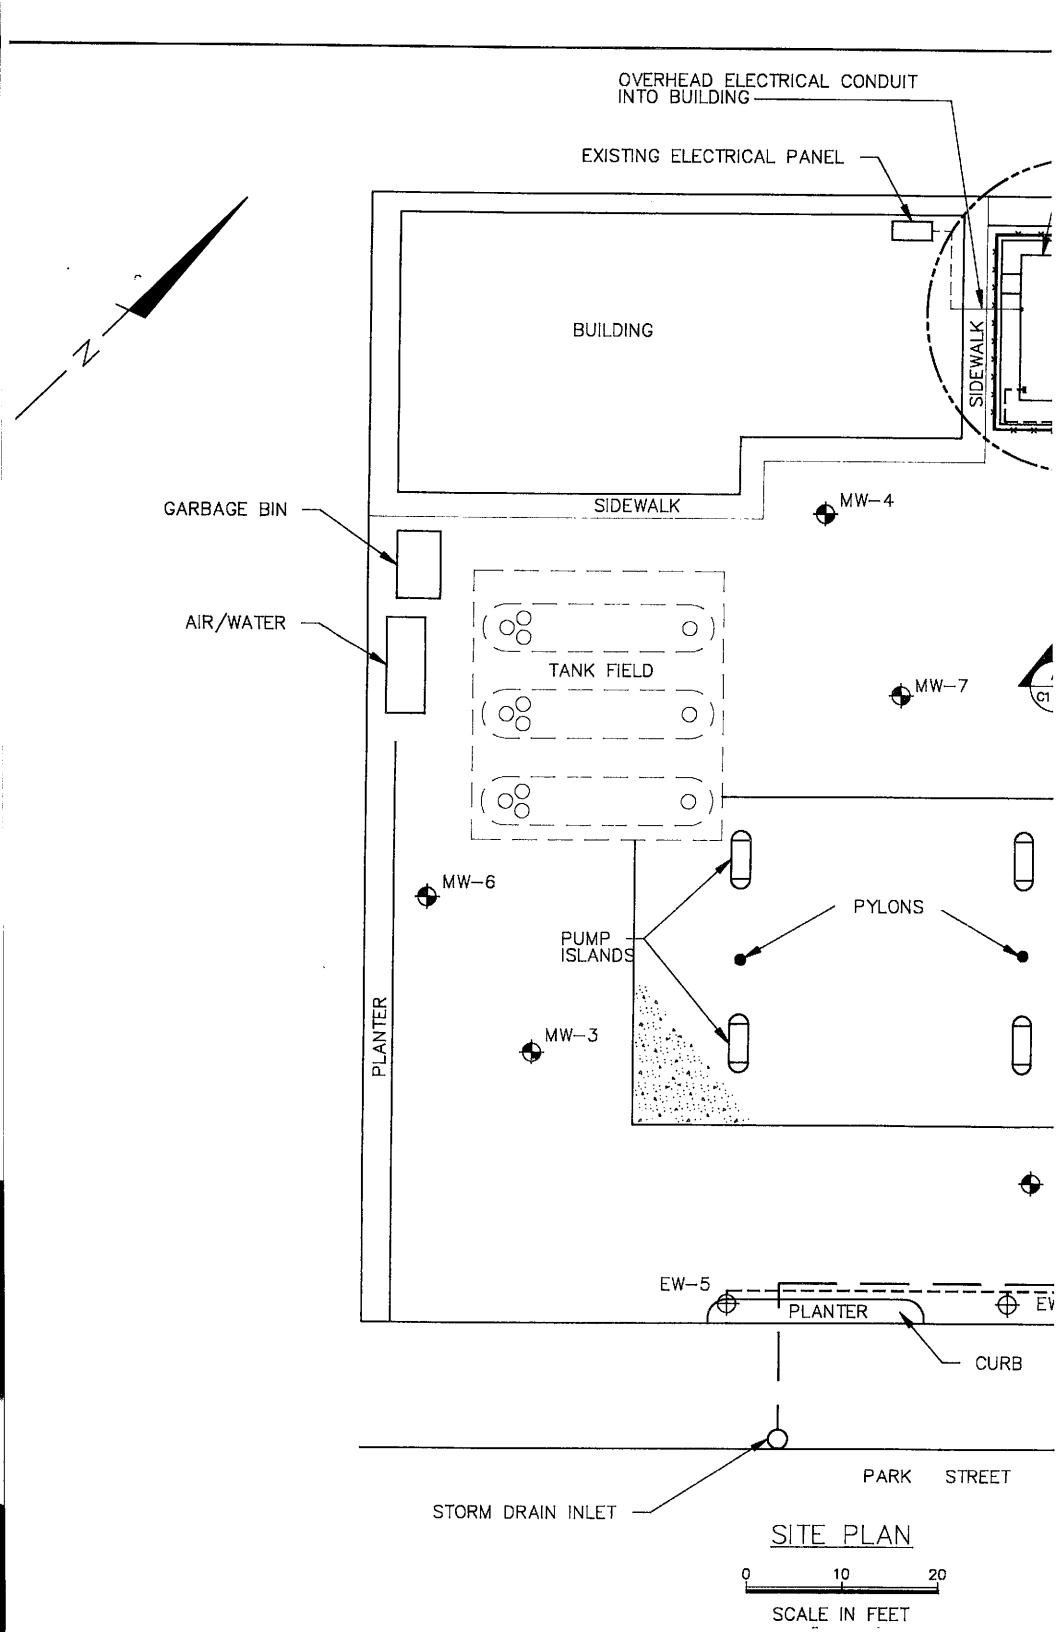



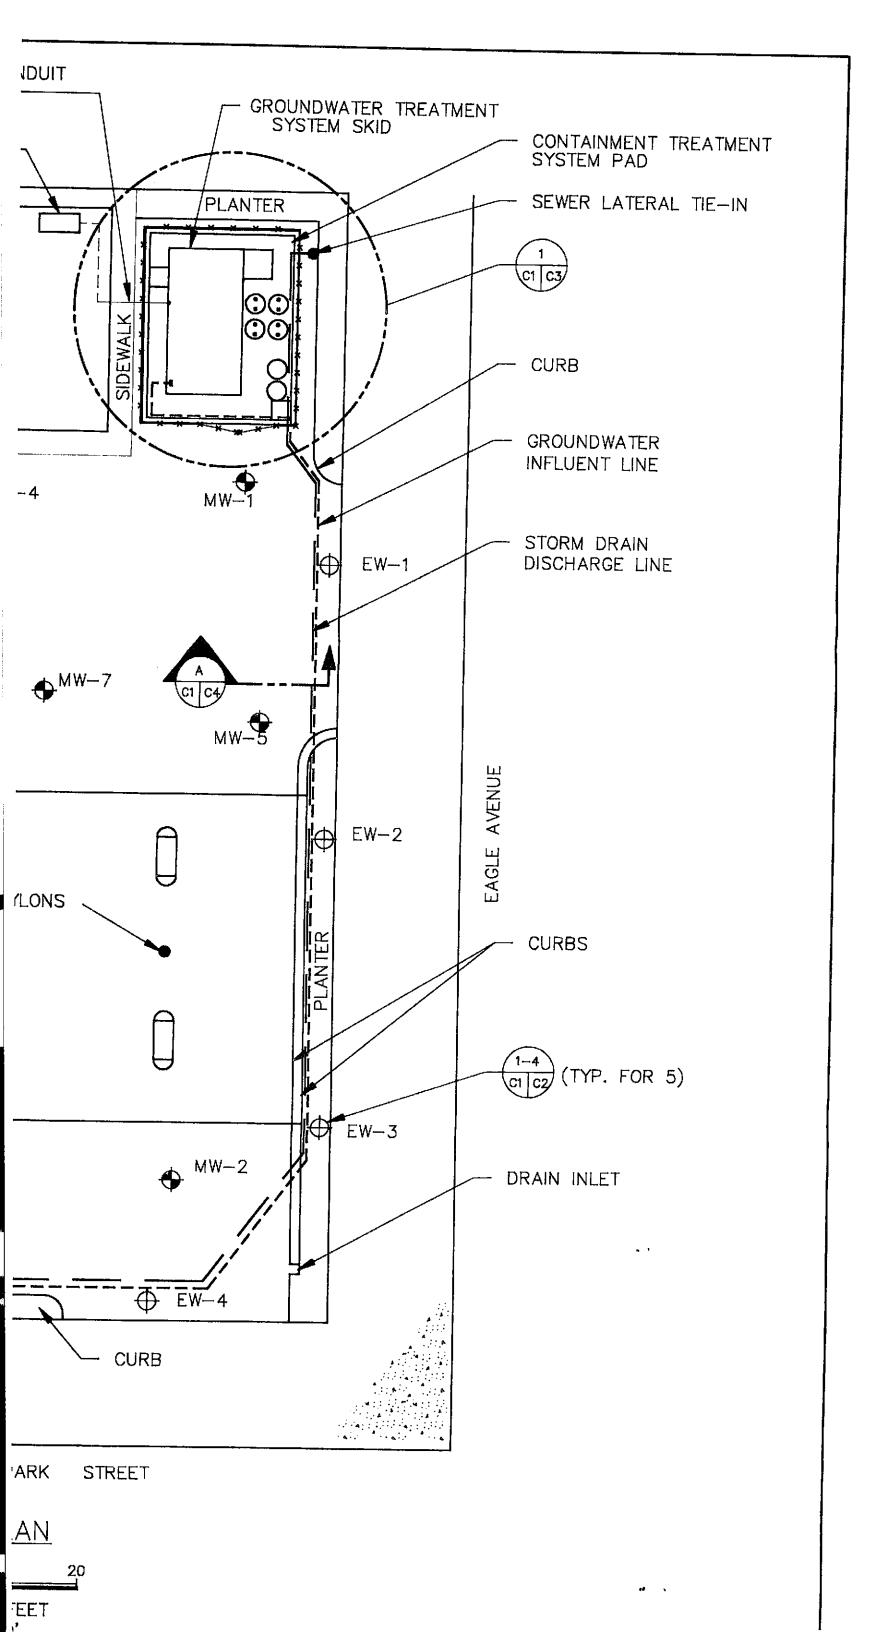

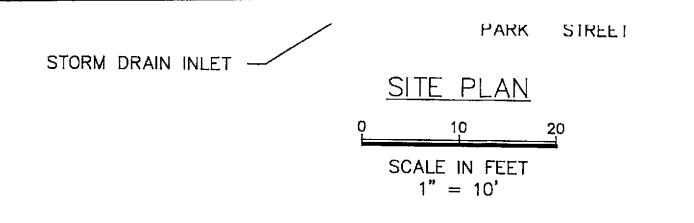

LEGEND

MONITORING WELL

EXTRACTION WELL

GROUNDWATER COLLECTION LINE

GROUNDWATER DISCHARGE LINE

ON STATION #7-0104

PARK STREET EDA, CALIFORNIA

GROUNDWATER RECOVERY SYSTEM

JOB NO.:


04167,390.02


DRAWING NO .:

C1

REV.:

VICINITY MAP & SITE PLAN

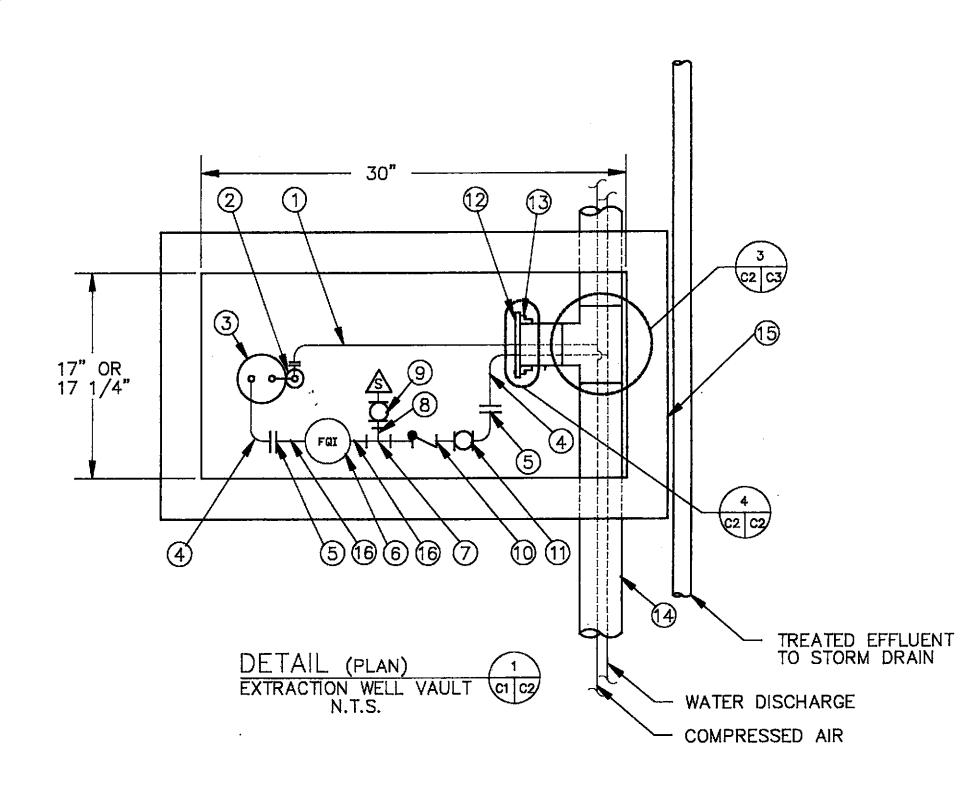

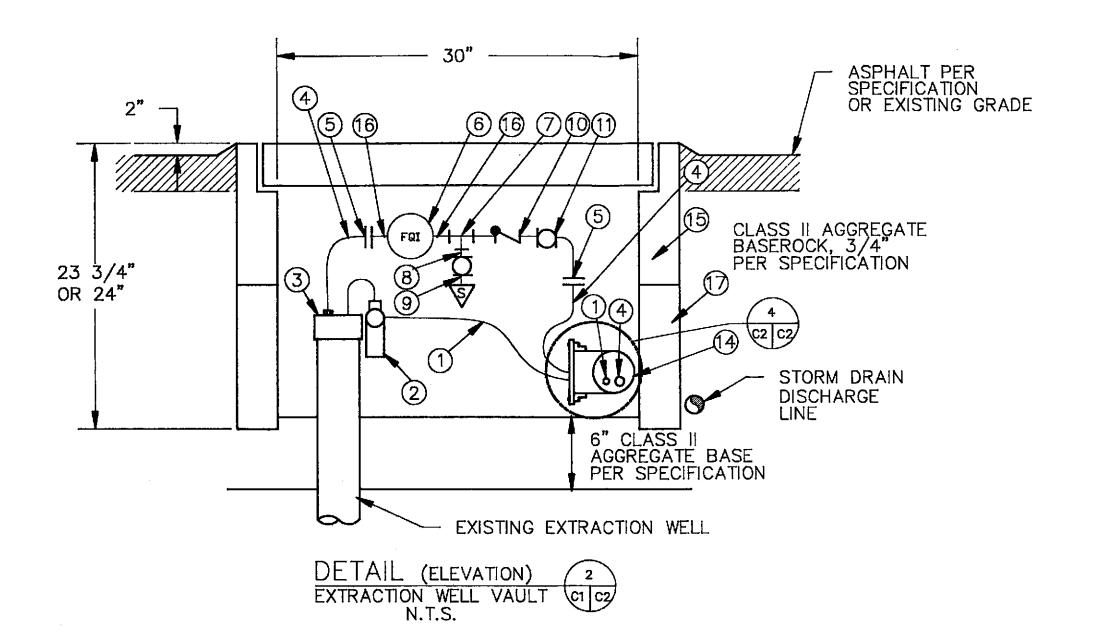


BILL OF MATERIALS:

- 1) 1/2" I.D. PRIMO-FLEX NYLON TUBING, 200 PSI RATING
- QED "SOLO" AIR FILTER/REGULATOR, SUPPLIED BY OWNER
- 3 QED "SOLO" WELL CAP, SUPPLIED BY OWNER
- 4 3/4" I.D. PRIMO-FLEX NYLON TUBING, 200 PSI RATING
- (5) 3/4" X 3/4" PVC SOCKET X HOSE BARB ADAPTER
- 6 FLOW TOTALIZER, KENT C-700 5/8" X 3/4" OR EQUIVALENT, 0.25 GPM MINIMUM MEASURABLE FLOW RATE
- 7 3/4" X 3/4" X 1/2" (ALL SOCKET) PVC REDUCING TEE AND 1/2" X 1/4" SOCKET X SOCKET PVC REDUCING BUSHING
- 8 1/4" SCH. 80 PVC PIPE
- 9 1/4" PVC FPT ADAPTER AND 1/4" PVC MPT X HOSE BARB LABCOCK VALVE
- 10 3/4" PVC BALL CHECK VALVE WITH UNION CONNECTORS
- (1) 3/4" PVC TRUE UNION BALL VALVE
- 12 4" PVC SCH. 80 BLIND FLANGE
- 13 4" PVC SCH. 80 SOCKET FLANGE
- 4" SCH. 80 PVC PIPE
- 15 17" X 30" X 12" VAULT BOX (CHRISTY N17" X 30" BOX H/20 LOADING, SCREW DOWN COVER, OR EQUIVALENT FOR WELLS EW-1 AND EW-4; CHRISTY N36 ELECTRICAL BOX, FIBERLYTE LID W/HOLD DOWN BOLTS OR EQUIVALENT FOR WELLS EW-2, EW-3, AND EW-5.)
- (16) 3/4" SCH. 80 PVC PIPE
- 17" X 30" X 12" EXTENSION BOX (CHRISTY N17" X 30" BOX H/20 LOADING OR EQUIVALENT FOR WELLS EW-1 AND EW-4; CHRISTY N36 12" EXTENSION OR EQUIVALENT FOR WELLS EW-2, EW-3, AND EW-5.)

NOTES:

- 1. APPLY TEFLON TAPE TO ALL THREADED CONNECTIONS.
- 2. ALL CLAMPS SHALL BE RATED AT 200 PSI.
- 3. PLACE TOP OF VAULT BOX 1/2" ABOVE EXISTING ASPHALT GRADE.

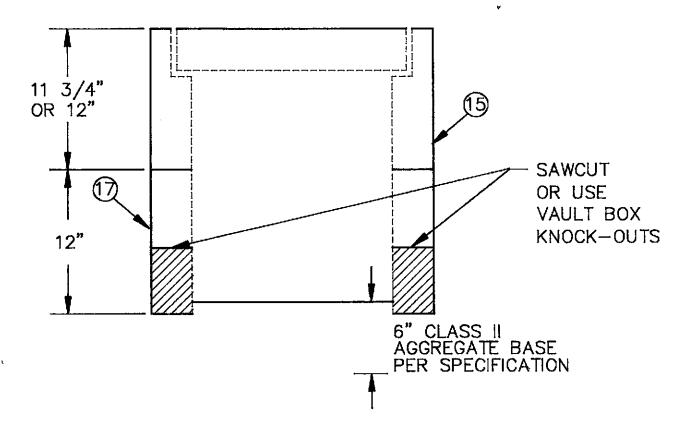


DETAIL (ELEVATION)
EXTRACTION WELL VAULT
N.T.S.

				,
		4	SCALE: AS SHOW	
			DESIGNED BY: CEM	
			DRAWN BY: JEB	
_			CHECKED BY: VA	۳
			DATE: 9/6/91	
			APPROVED BY:	
NO.	DATE	REVISIONS	BY DATE:	



Harding Engineerin Environme

P.O. Box 578 Novata, Califo (415) 892-082

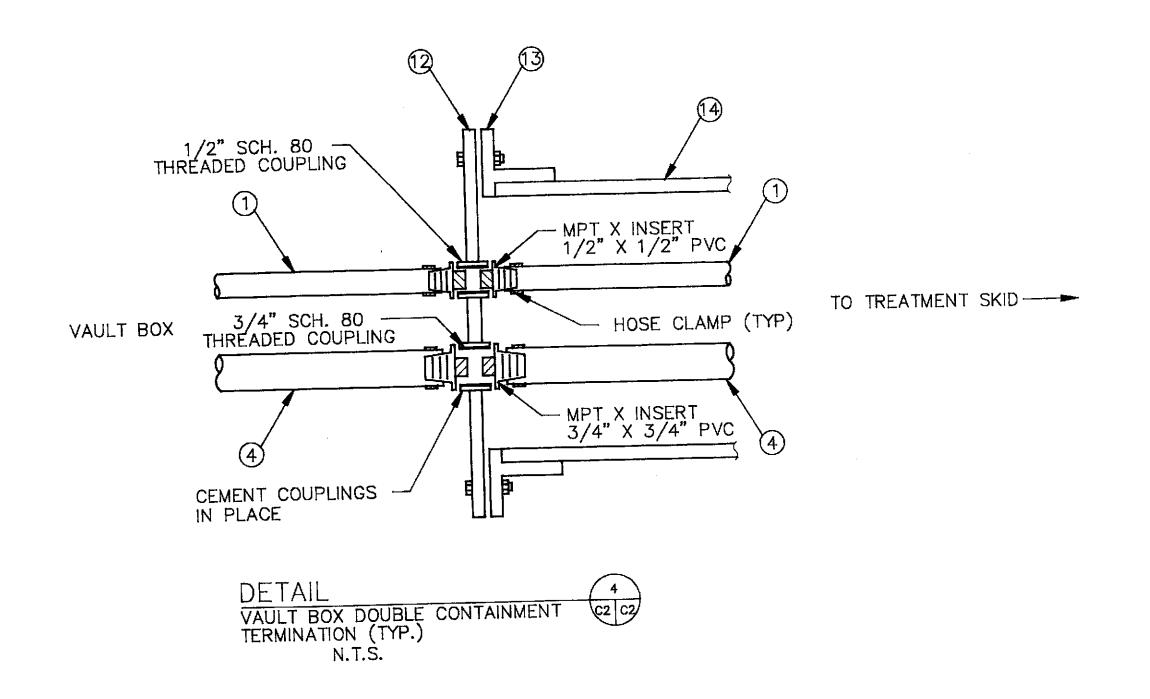

Harding Lawson Associates
Engineering and
Environmental Services


P.O. Box 578 Novato, California (415) 892-0821 EXXON STATION #7-0104


1725 PARK STREET ALAMEDA, CALIFORNIA


GROUNDWATER RECOVERY SYSTE

EXTRACTION WELL VAULT DETAILS

1

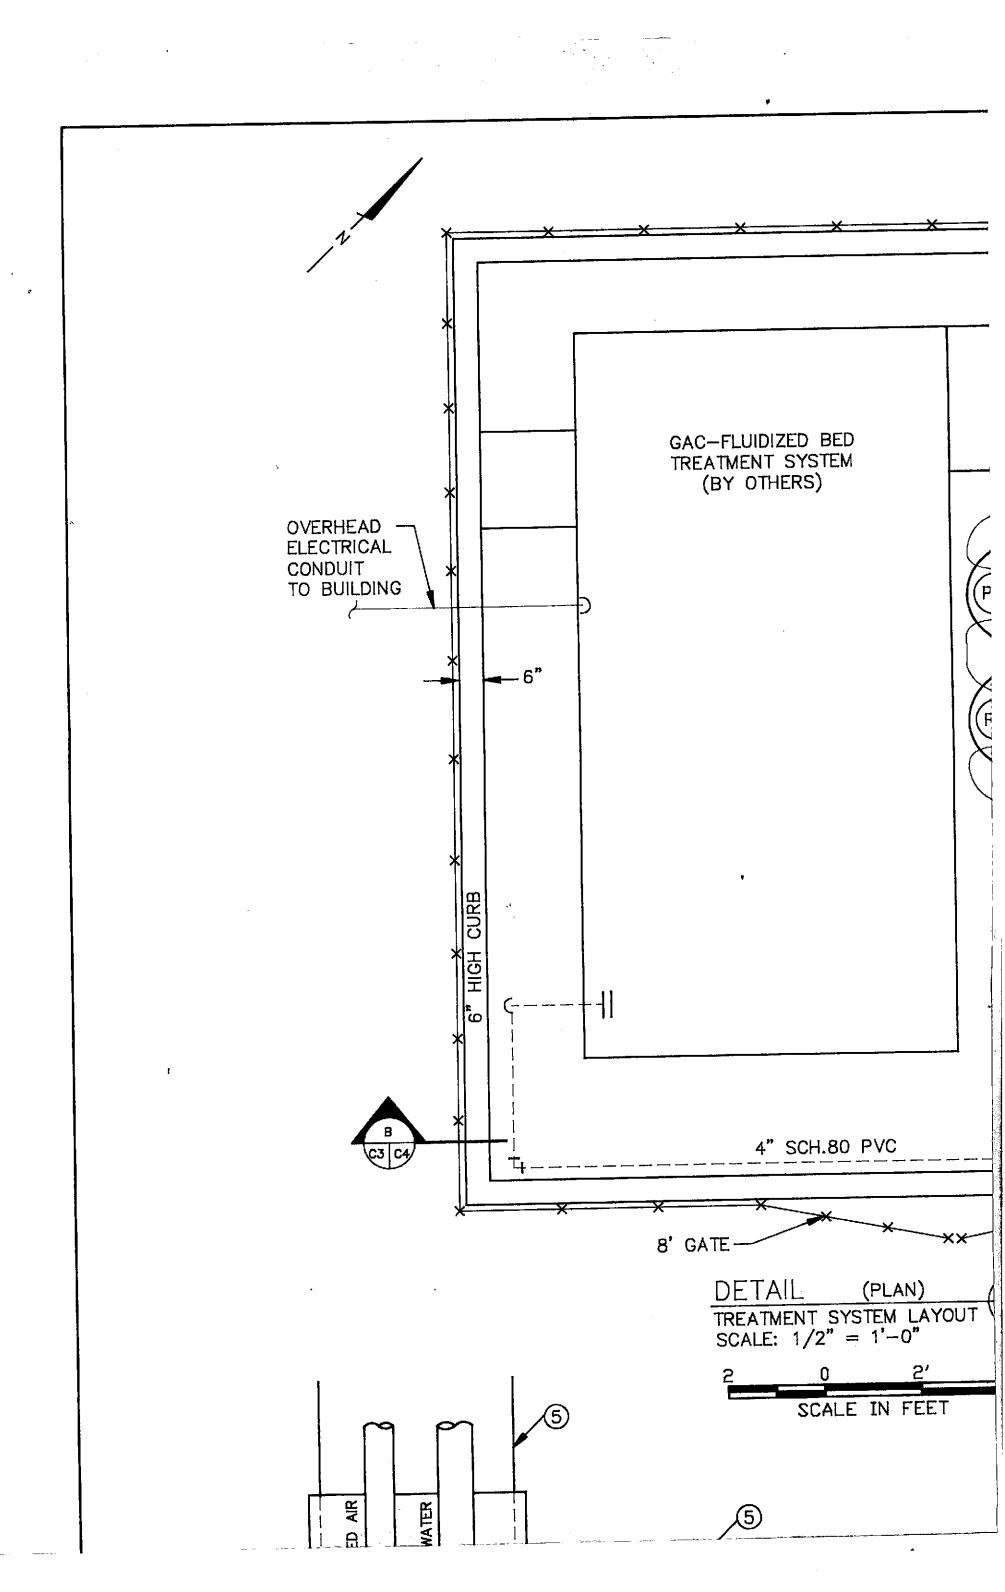

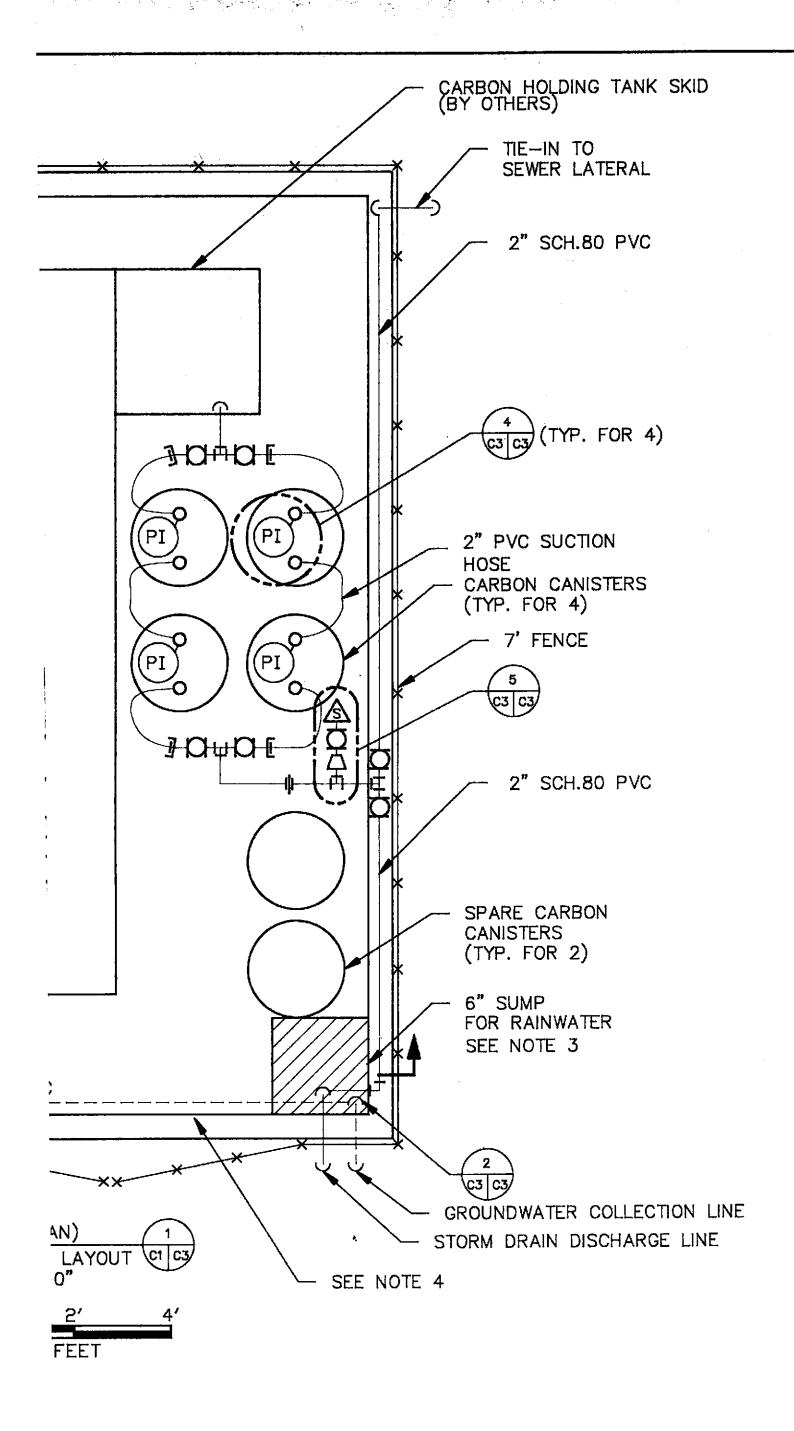

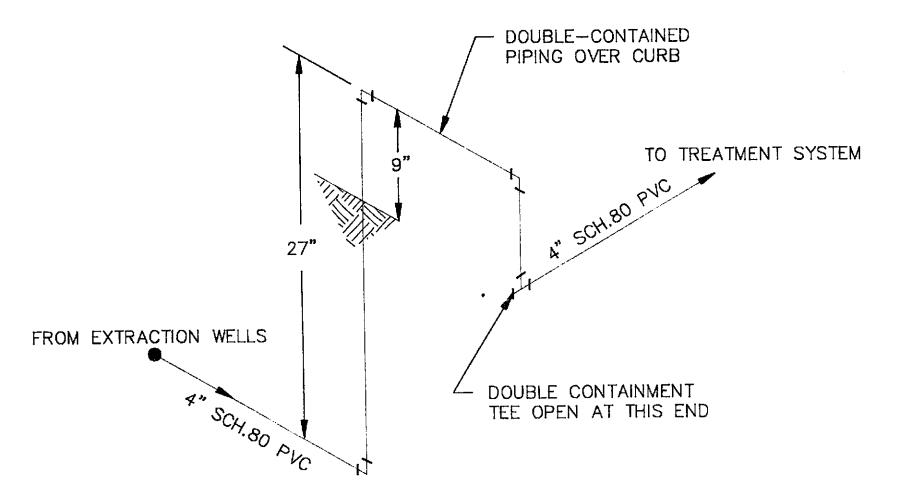

DETAIL (ISOMETRIC) 2

DOUBLE-CONTAINED PIPING C3 C3

OVER CURB


N.T.S.

BILL OF MATERIALS:


- (1) 1" I.D. PRIMO-FLEX NYLON TUBING, 200 PSI RATING
- (2) 3/4" I.D. PRIMO-FLEX NYLON TUBING, 200 PSI RATING
- (3) 3/4" I.D. PRIMO-FLEX NYLON TUBING, 200 PSI RATING
- (4) 1/2" I.D. PRIMO-FLEX NYLON TUBING, 200 PSI RATING
- (5) 4" SCH. 80 PVC PIPE
- 6 4" X 4" X 4" PVC TEE, 2-PIECE, "FLO-SAFE" OR APPROVED EQUIVALENT
- (7) 3/4" X 3/4" X 1/2" (ALL HOSE BARB) PVC REDUCING TEE
- (8) 1" X 1" X 3/4" (ALL HOSE BARB) PVC REDUCING TEE
- (9) HOSE CLAMP, 200 PSI RATED
- (10) 2" PVC SUCTION HOSE, HEAVY DUTY, GREEN
- (1) QUICK-CONNECT COUPLING AND FITTINGS
- (12) 2" SCH. 80 PVC PIPE
- (3) 2" X 2" X 1/2" SCH.80 PVC REDUCING TEE
- 14) PRESSURE INDICATOR, 0 20 PSI RANGE
- (15) 1/2" X 1/2" X 1/4" SCH.80 PVC REDUCING TEE
- 1/4" PVC FPT ADAPTER AND 1/4" PVC MPT X HOSE BARB LABCOCK VALVE
- 1/2" X 1/4" SCH. 80 PVC REDUCER BUSHING.

NOTES:

- 1. APPLY TEFLON TAPE TO ALL THREADED CONNECTIONS.
- 2. ALL CLAMPS SHALL BE RATED AT 200 PSI.
- 3. PROVIDE DRAIN LINE FROM BOTTOM OF SUMP TO PLANTER AREA OUTSIDE OF CURB WITH BALL VALVE ON SUMP SIDE.
- 4. PROVIDE SET OF TWO REMOVABLE STEEL RAMPS, EACH 4' X 2' X 1/4" CHECKER PLATE OVER 4" PVC PIPE AT GATE. RAMP ASPHALT TO TOP OF CURB OUTSIDE OF COMPOUND IN FRONT OF 8' GATE.

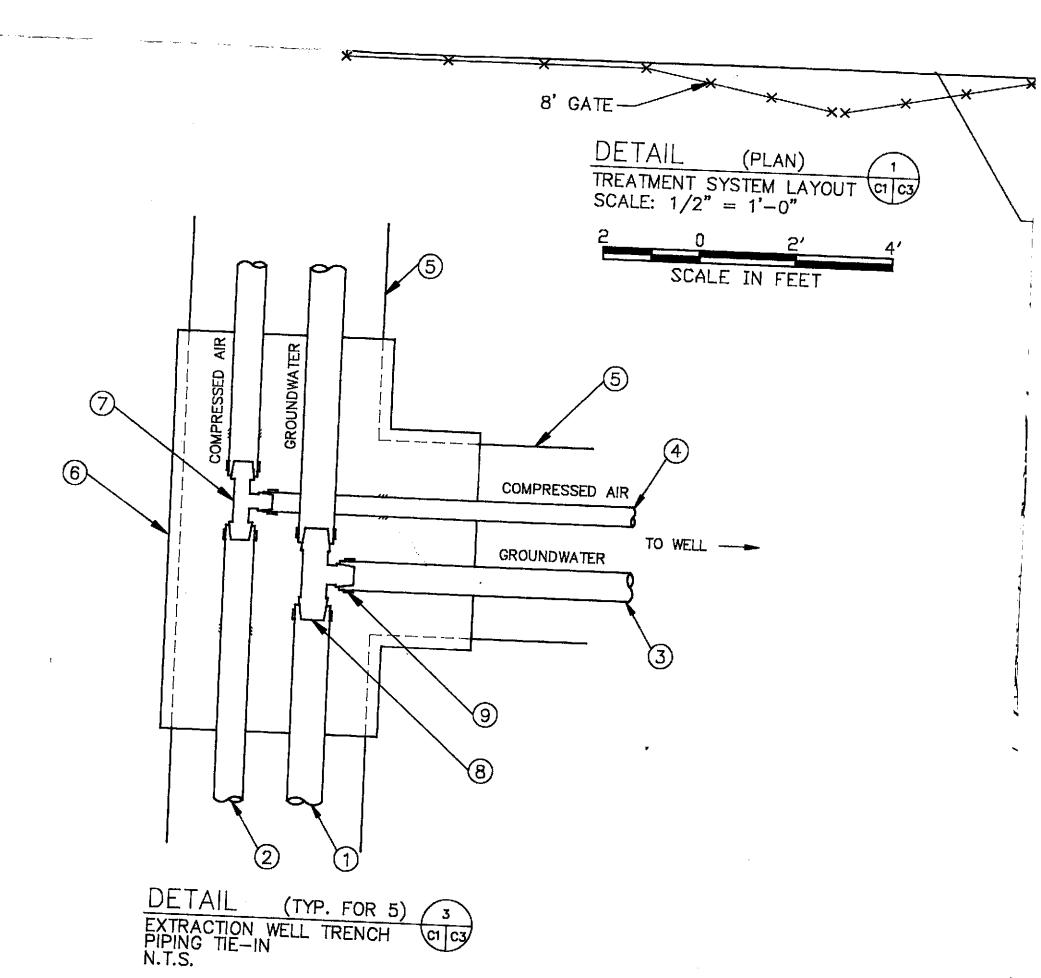

_				
			SCALE: AS SHOWN	
			DESIGNED BY: CEM	
			DRAWN RY. JED	7
			CHECKED BY: TOOL	
			DATE: 9/6/91	
E	REVISIONS	534	DATE: a/6/91 APPROVED BY: DATE:	
		BY	DATE:	
				-

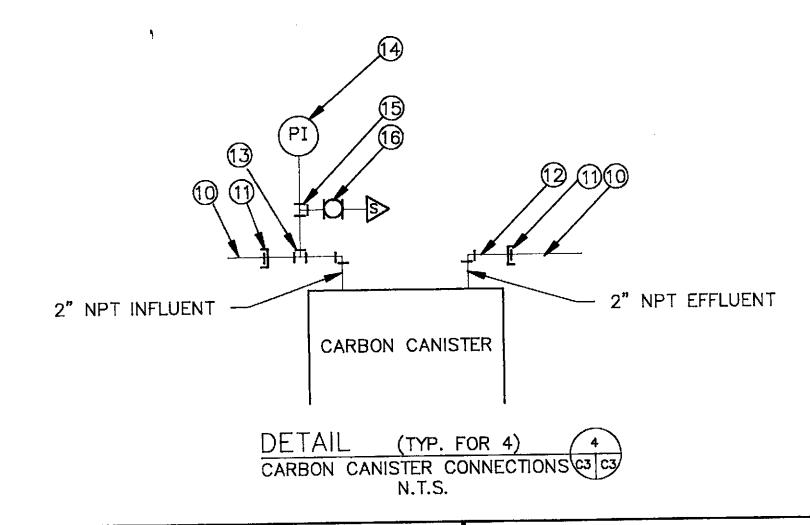


Harding Lawson Associates Engineering and Environmental Services

P.O. Box 578 Novato, California (415) 892-0821

EXXON STATION #7-0104


1725 PARK STREET ALAMEDA, CALIFORNIA

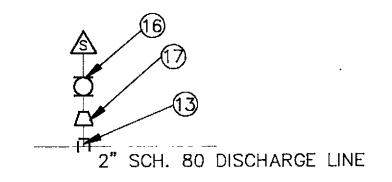


DETAIL
DISCHARGE SAMPLE PORT
N.T.S.

5

GROUNDWATER RECOVERY SYSTEM	SYSTEM JOB NO.: 04167,390.02	
TREATMENT SYSTEM LAYOUT DETAILS	DRAWING NO.:	REV.:

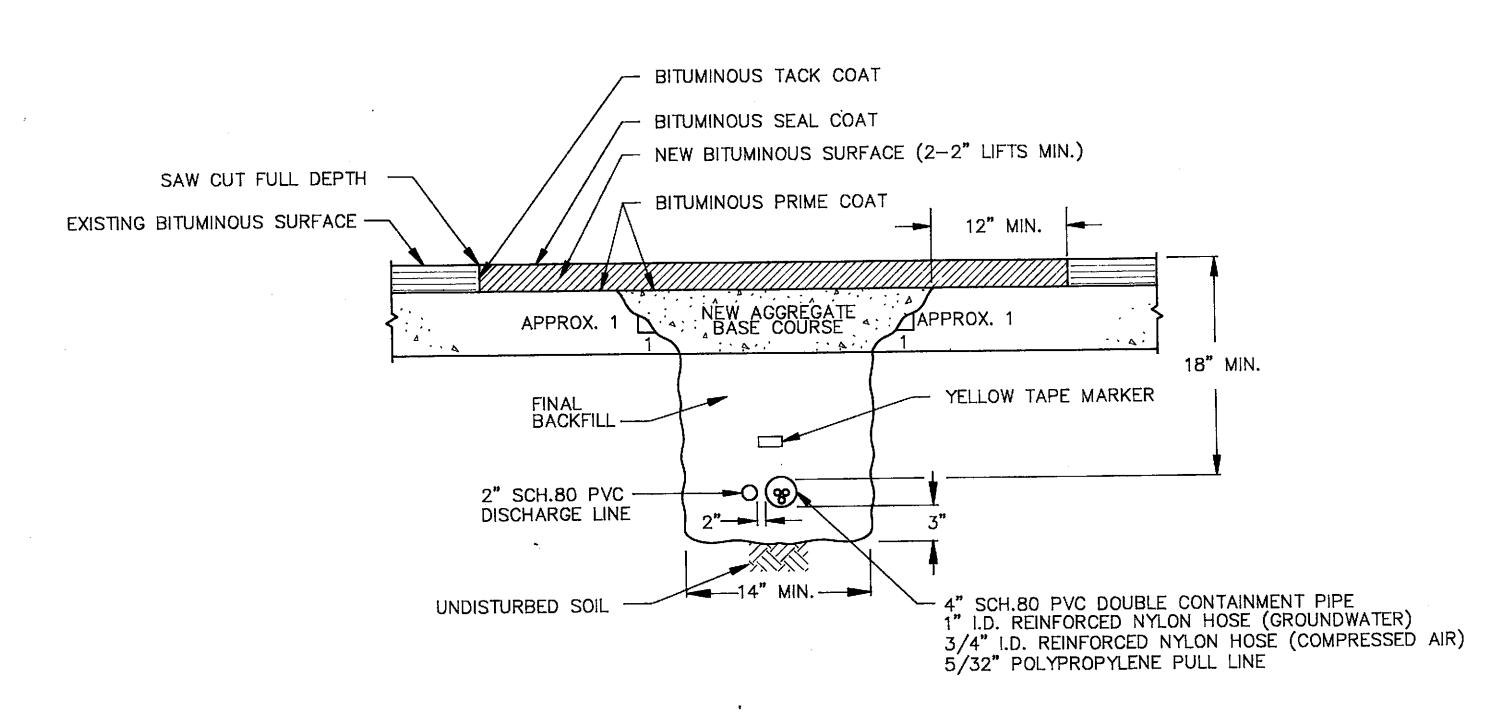



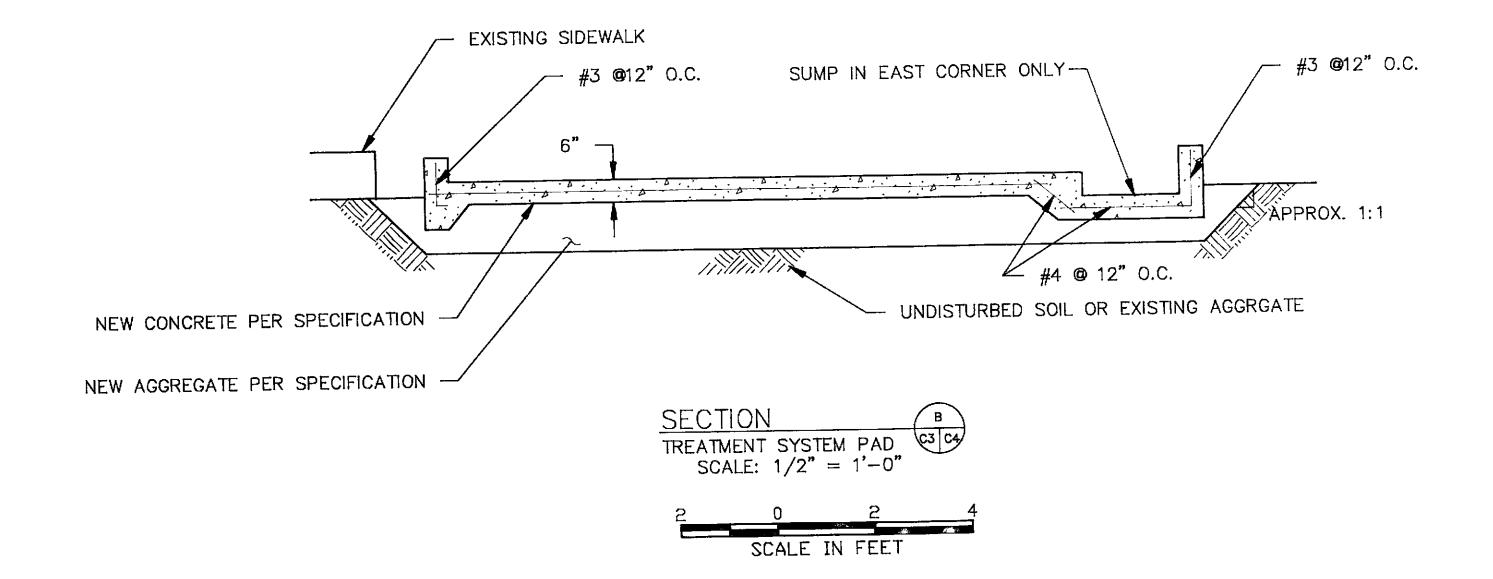

ı				
7				SCALE: AS SHOWN
				DESIGNED BY: CEM
				DRAWN BY: JEB
 	├			CHECKED BY: TOPAT DATE: 9/6/91
	├── ╅			DATE: 9/6/91
 	 	V		APPROVED BY:
1	DATE	REVISIONS	BY	DATE:
I MO.	INVIE			



Harding Lawson Associates

Engineering and Environmental Services

P.O. Box 578 Novato, California (415) 892—0821

EXXON STATION #7-0104

1725 PARK STREET ALAMEDA, CALIFORNIA GROUNDWATER RECOVERY SYSTEM

SECTIONS

JOB NO.:

04167,390.02

DRAWING NO .:

C4