



# 301 19TH STREET


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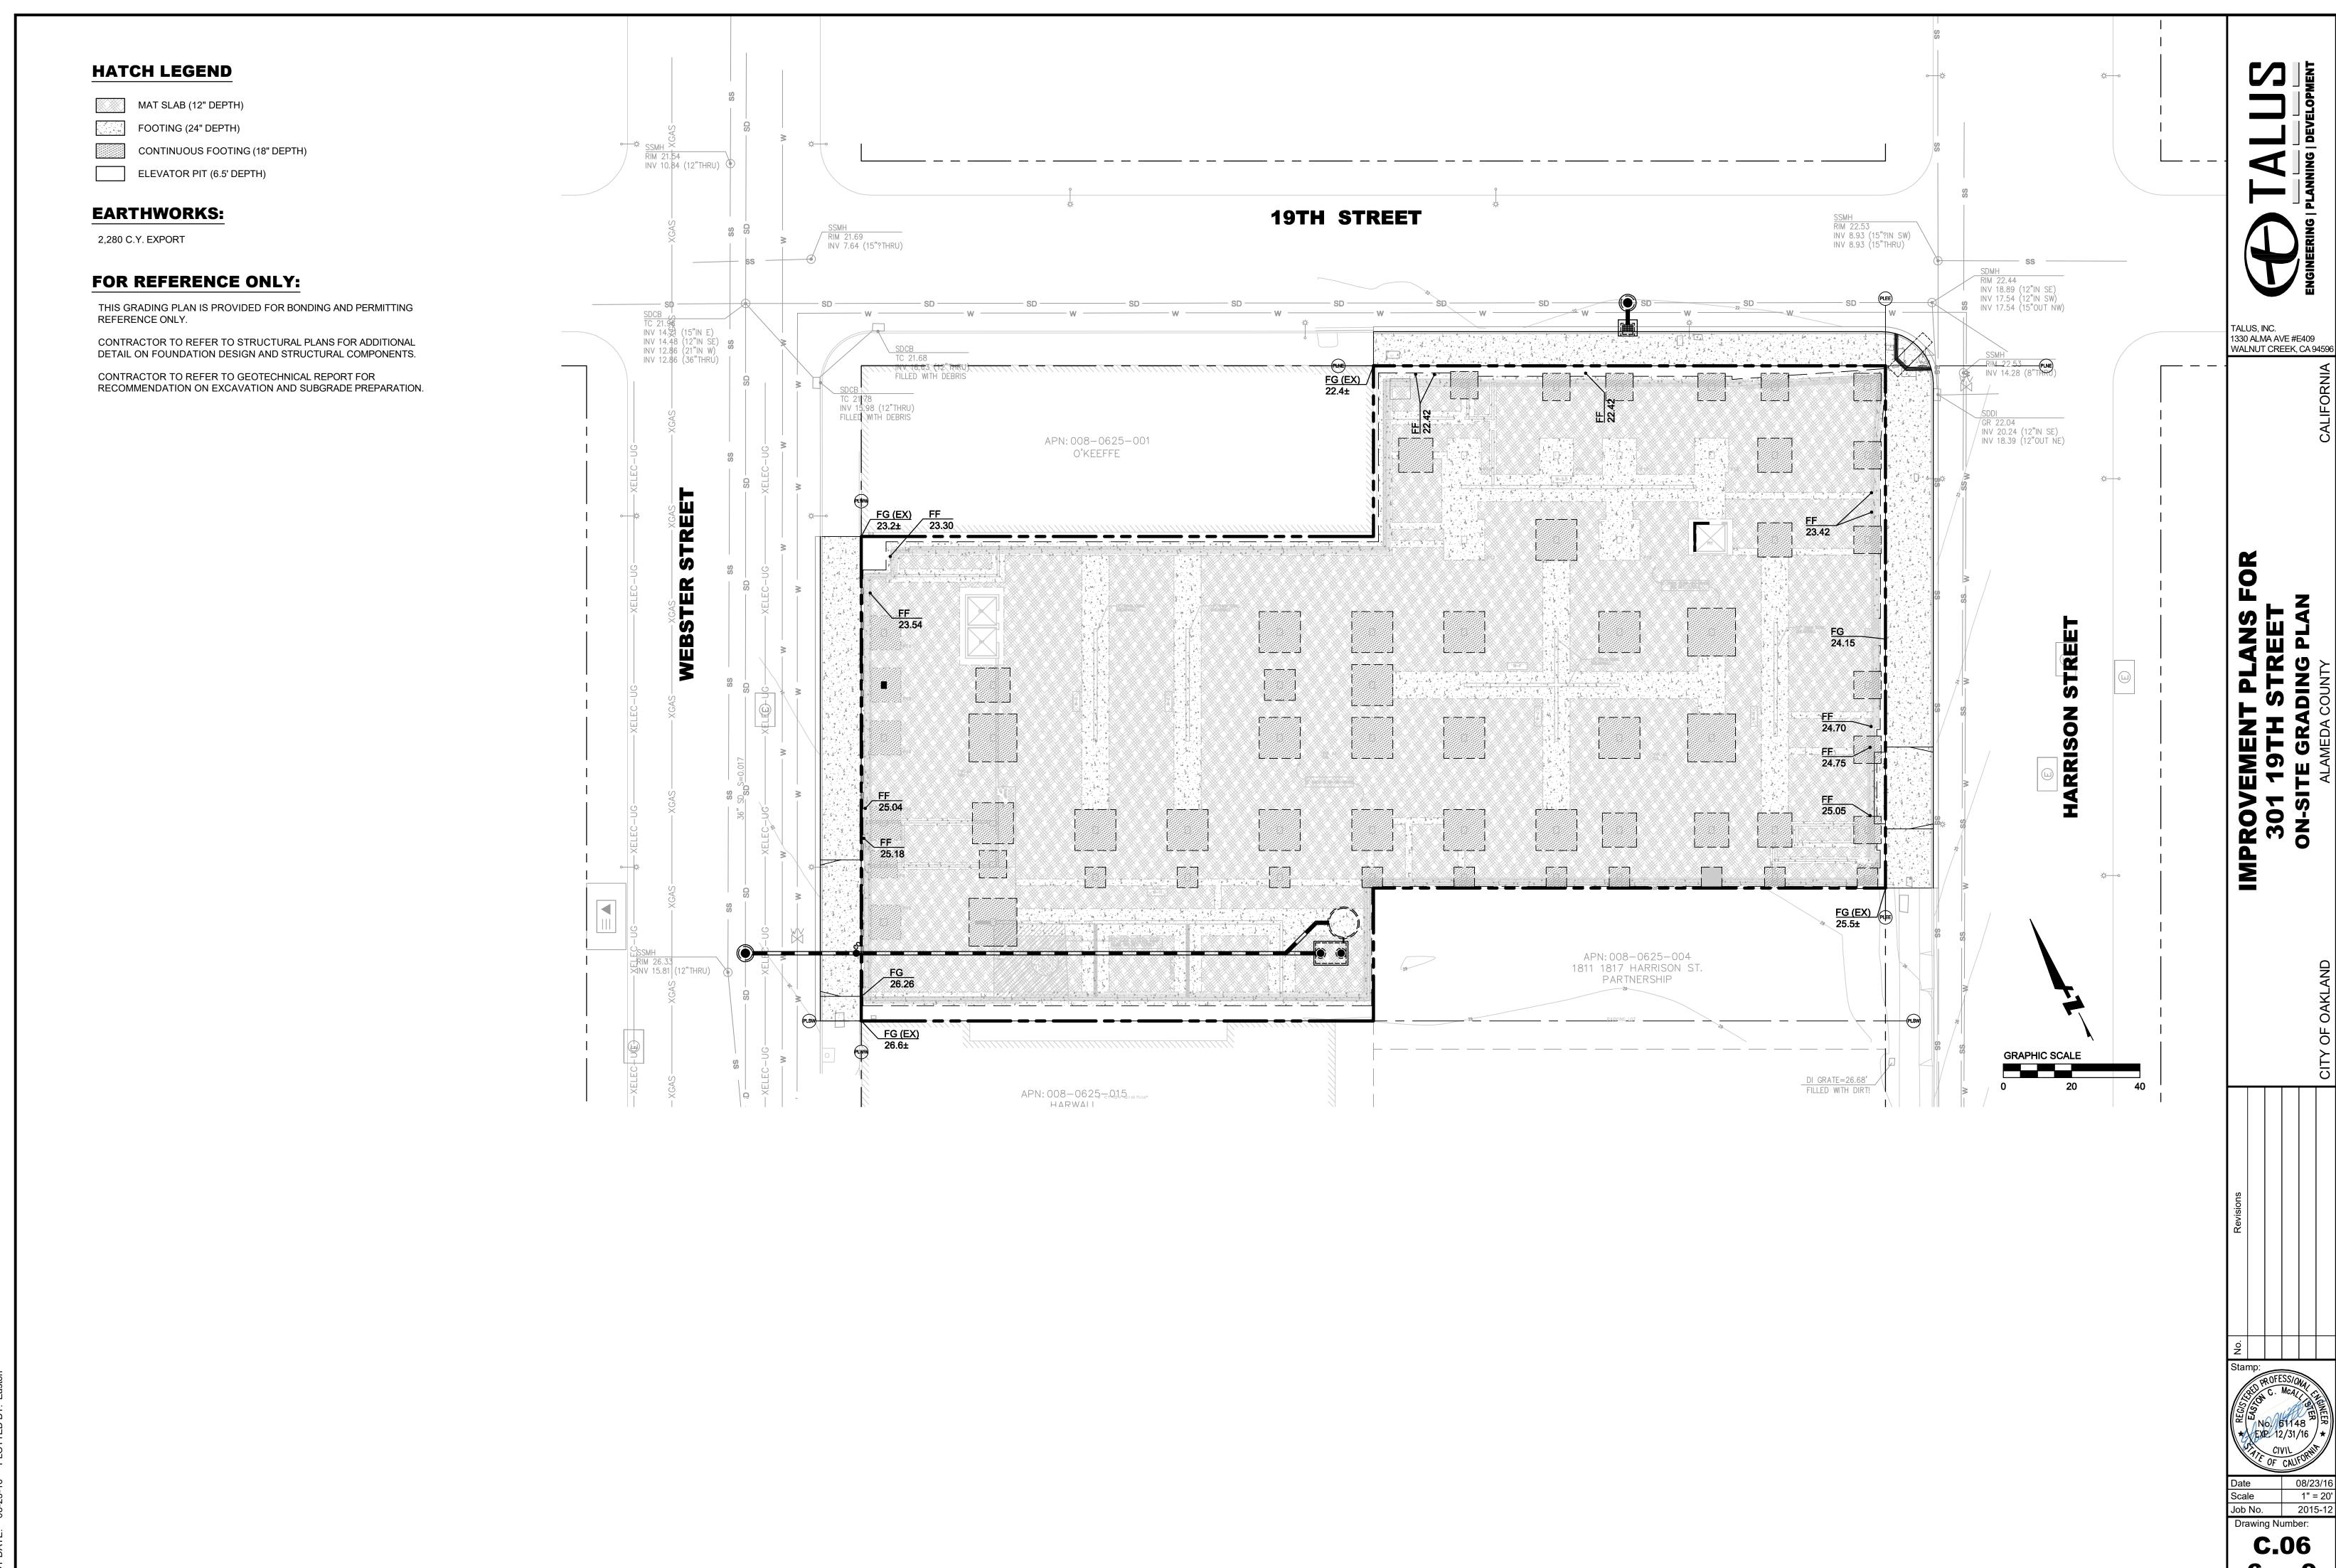




VOLUME 1


Project # 1132-0018




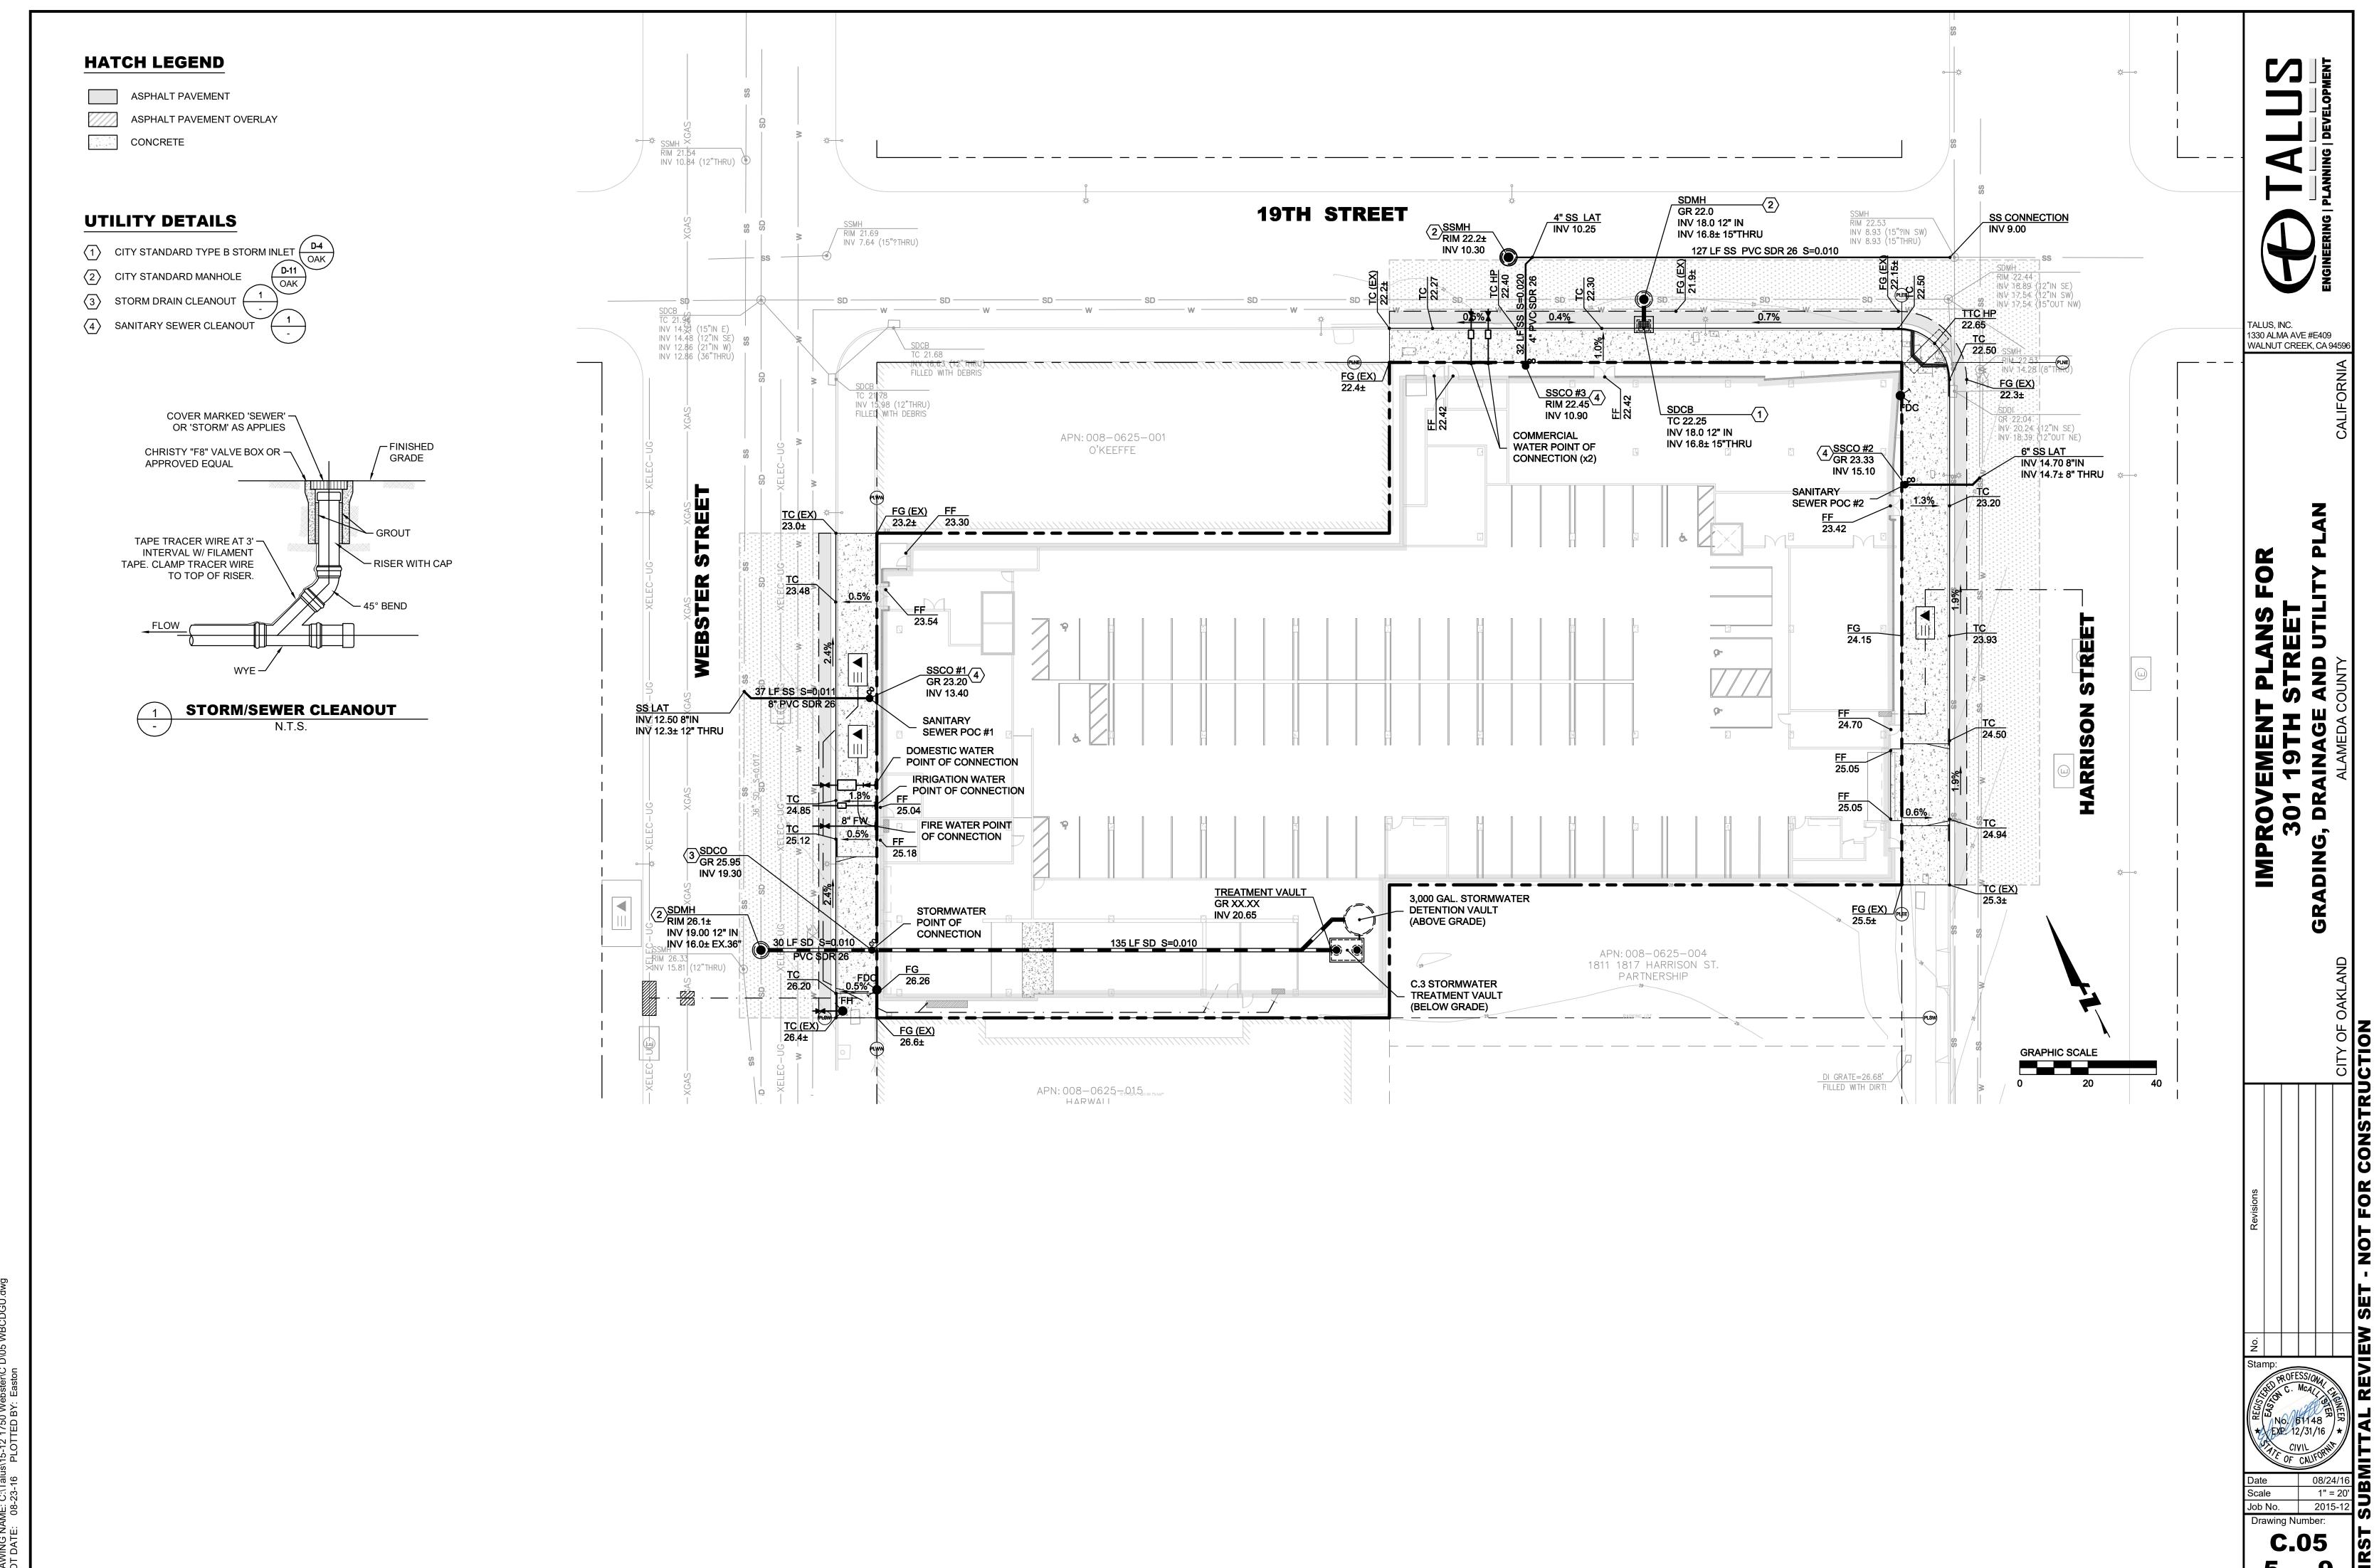



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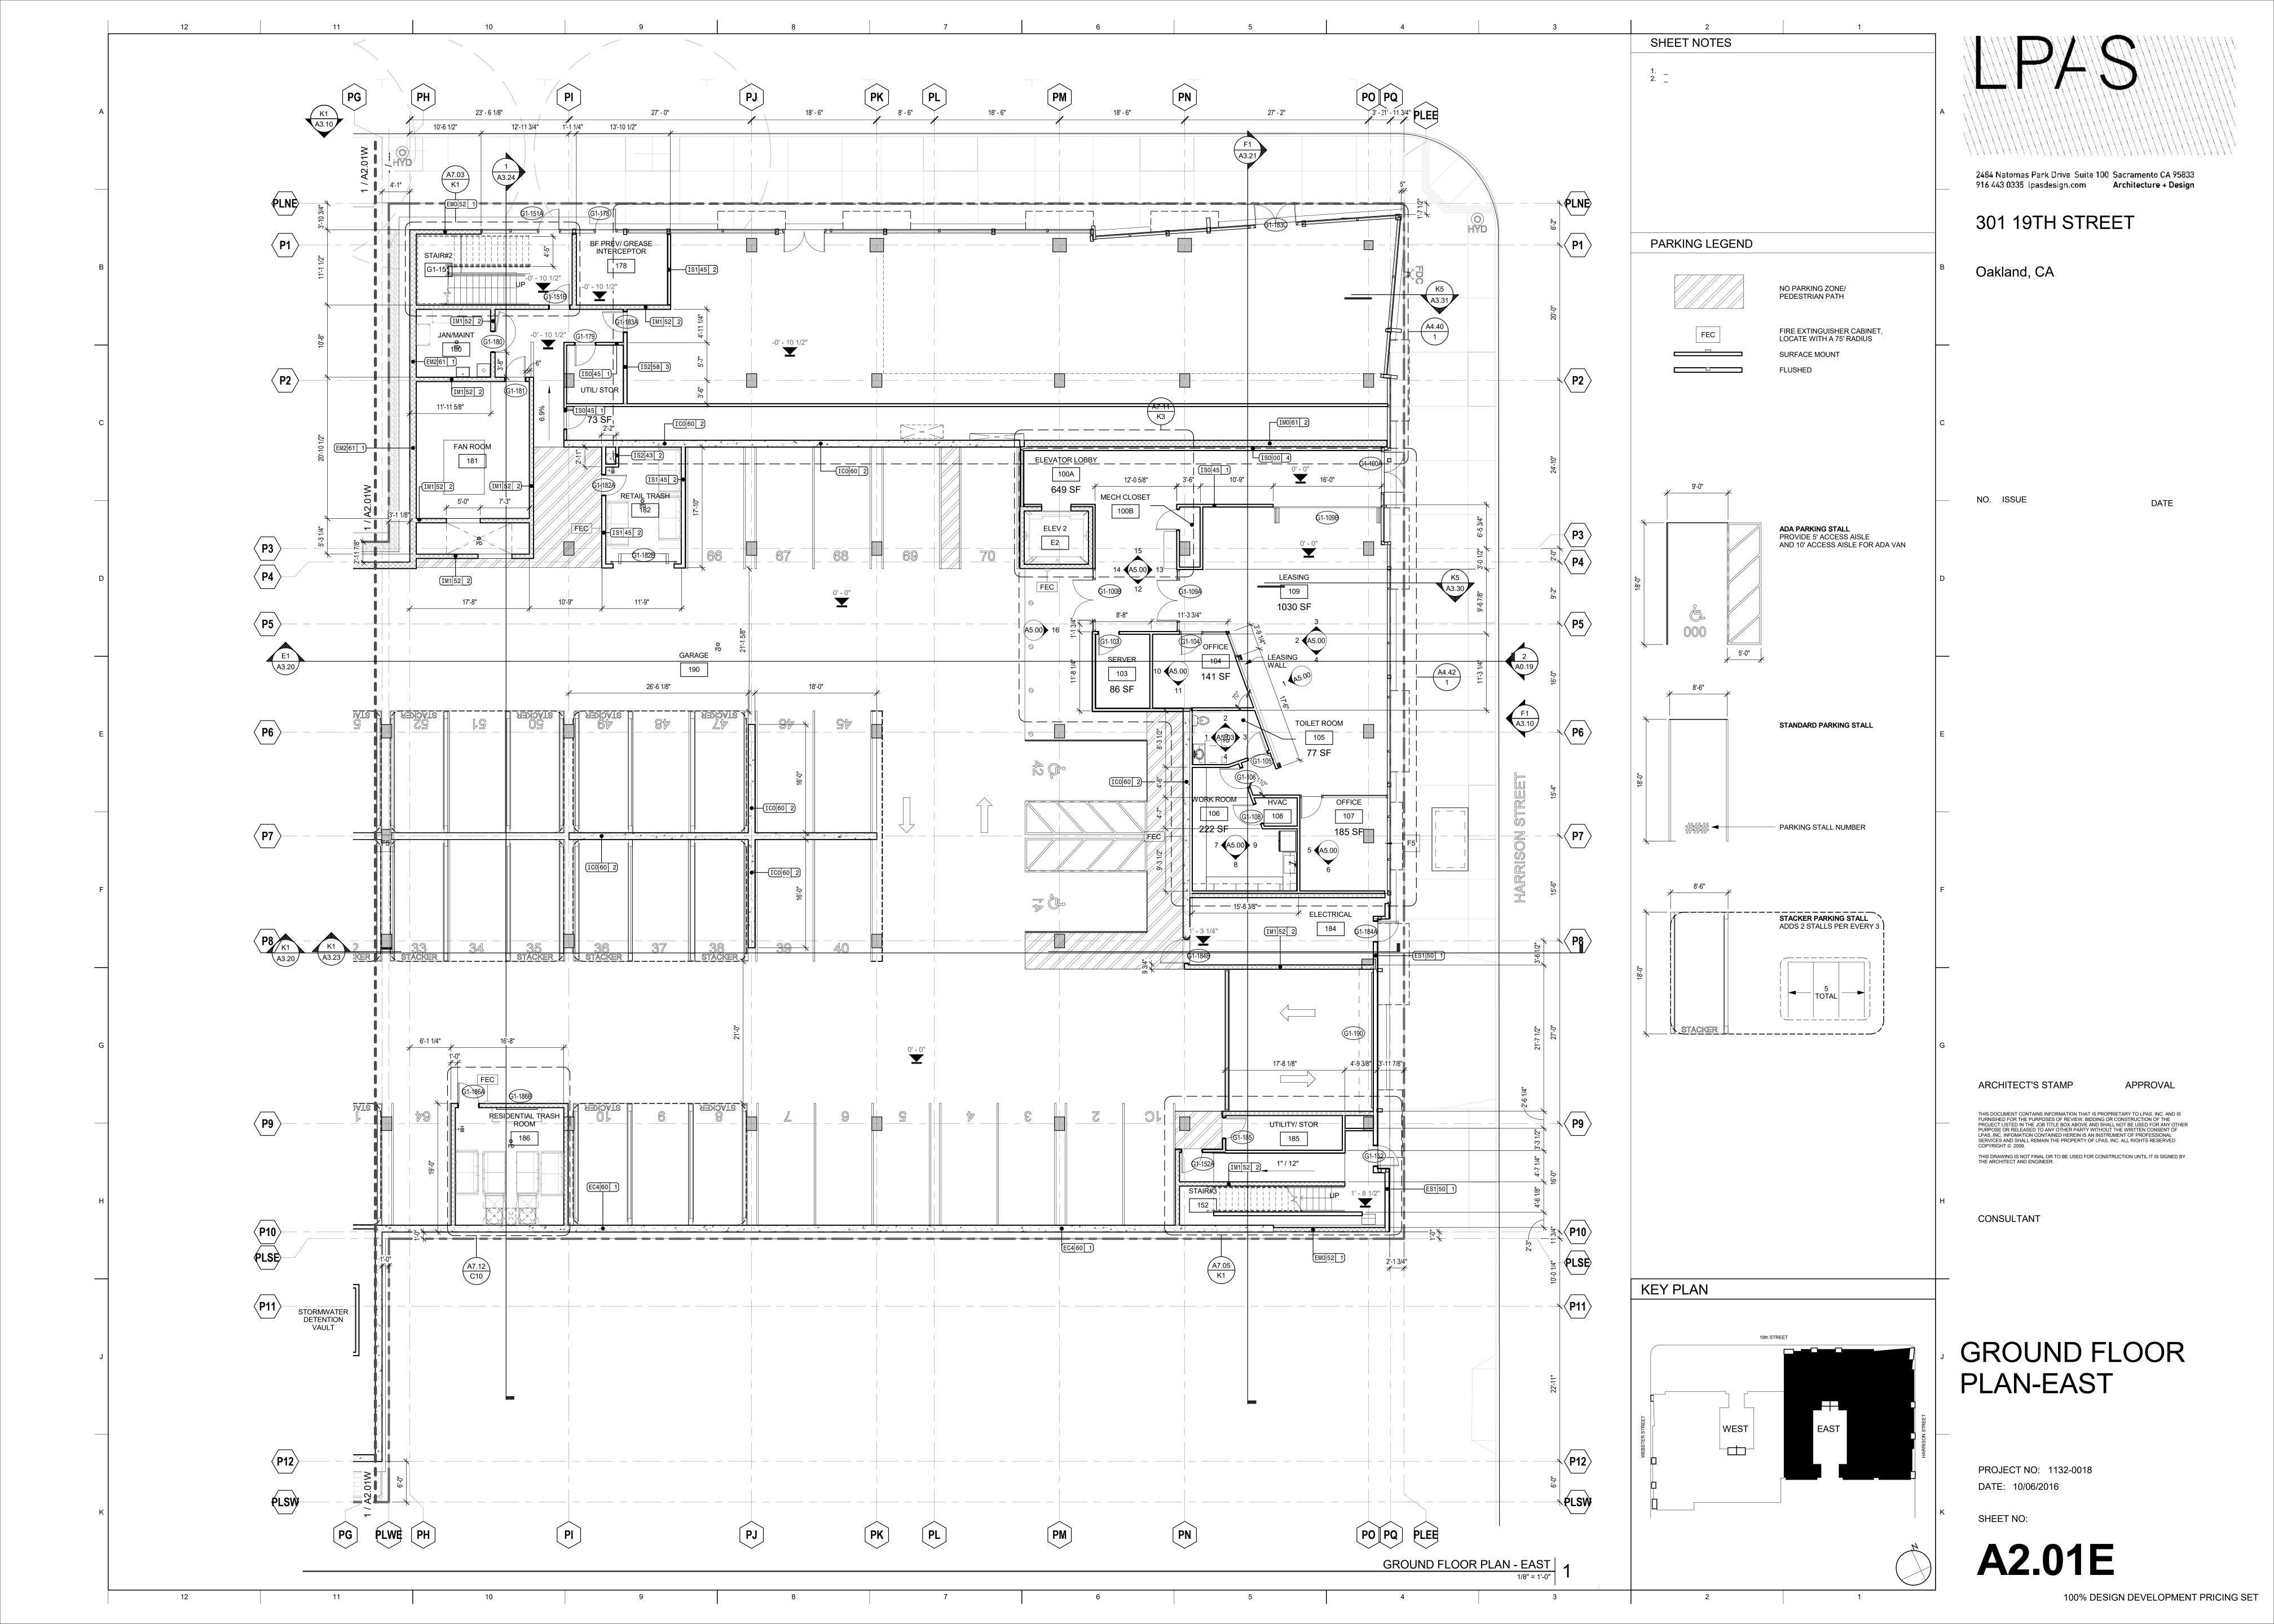
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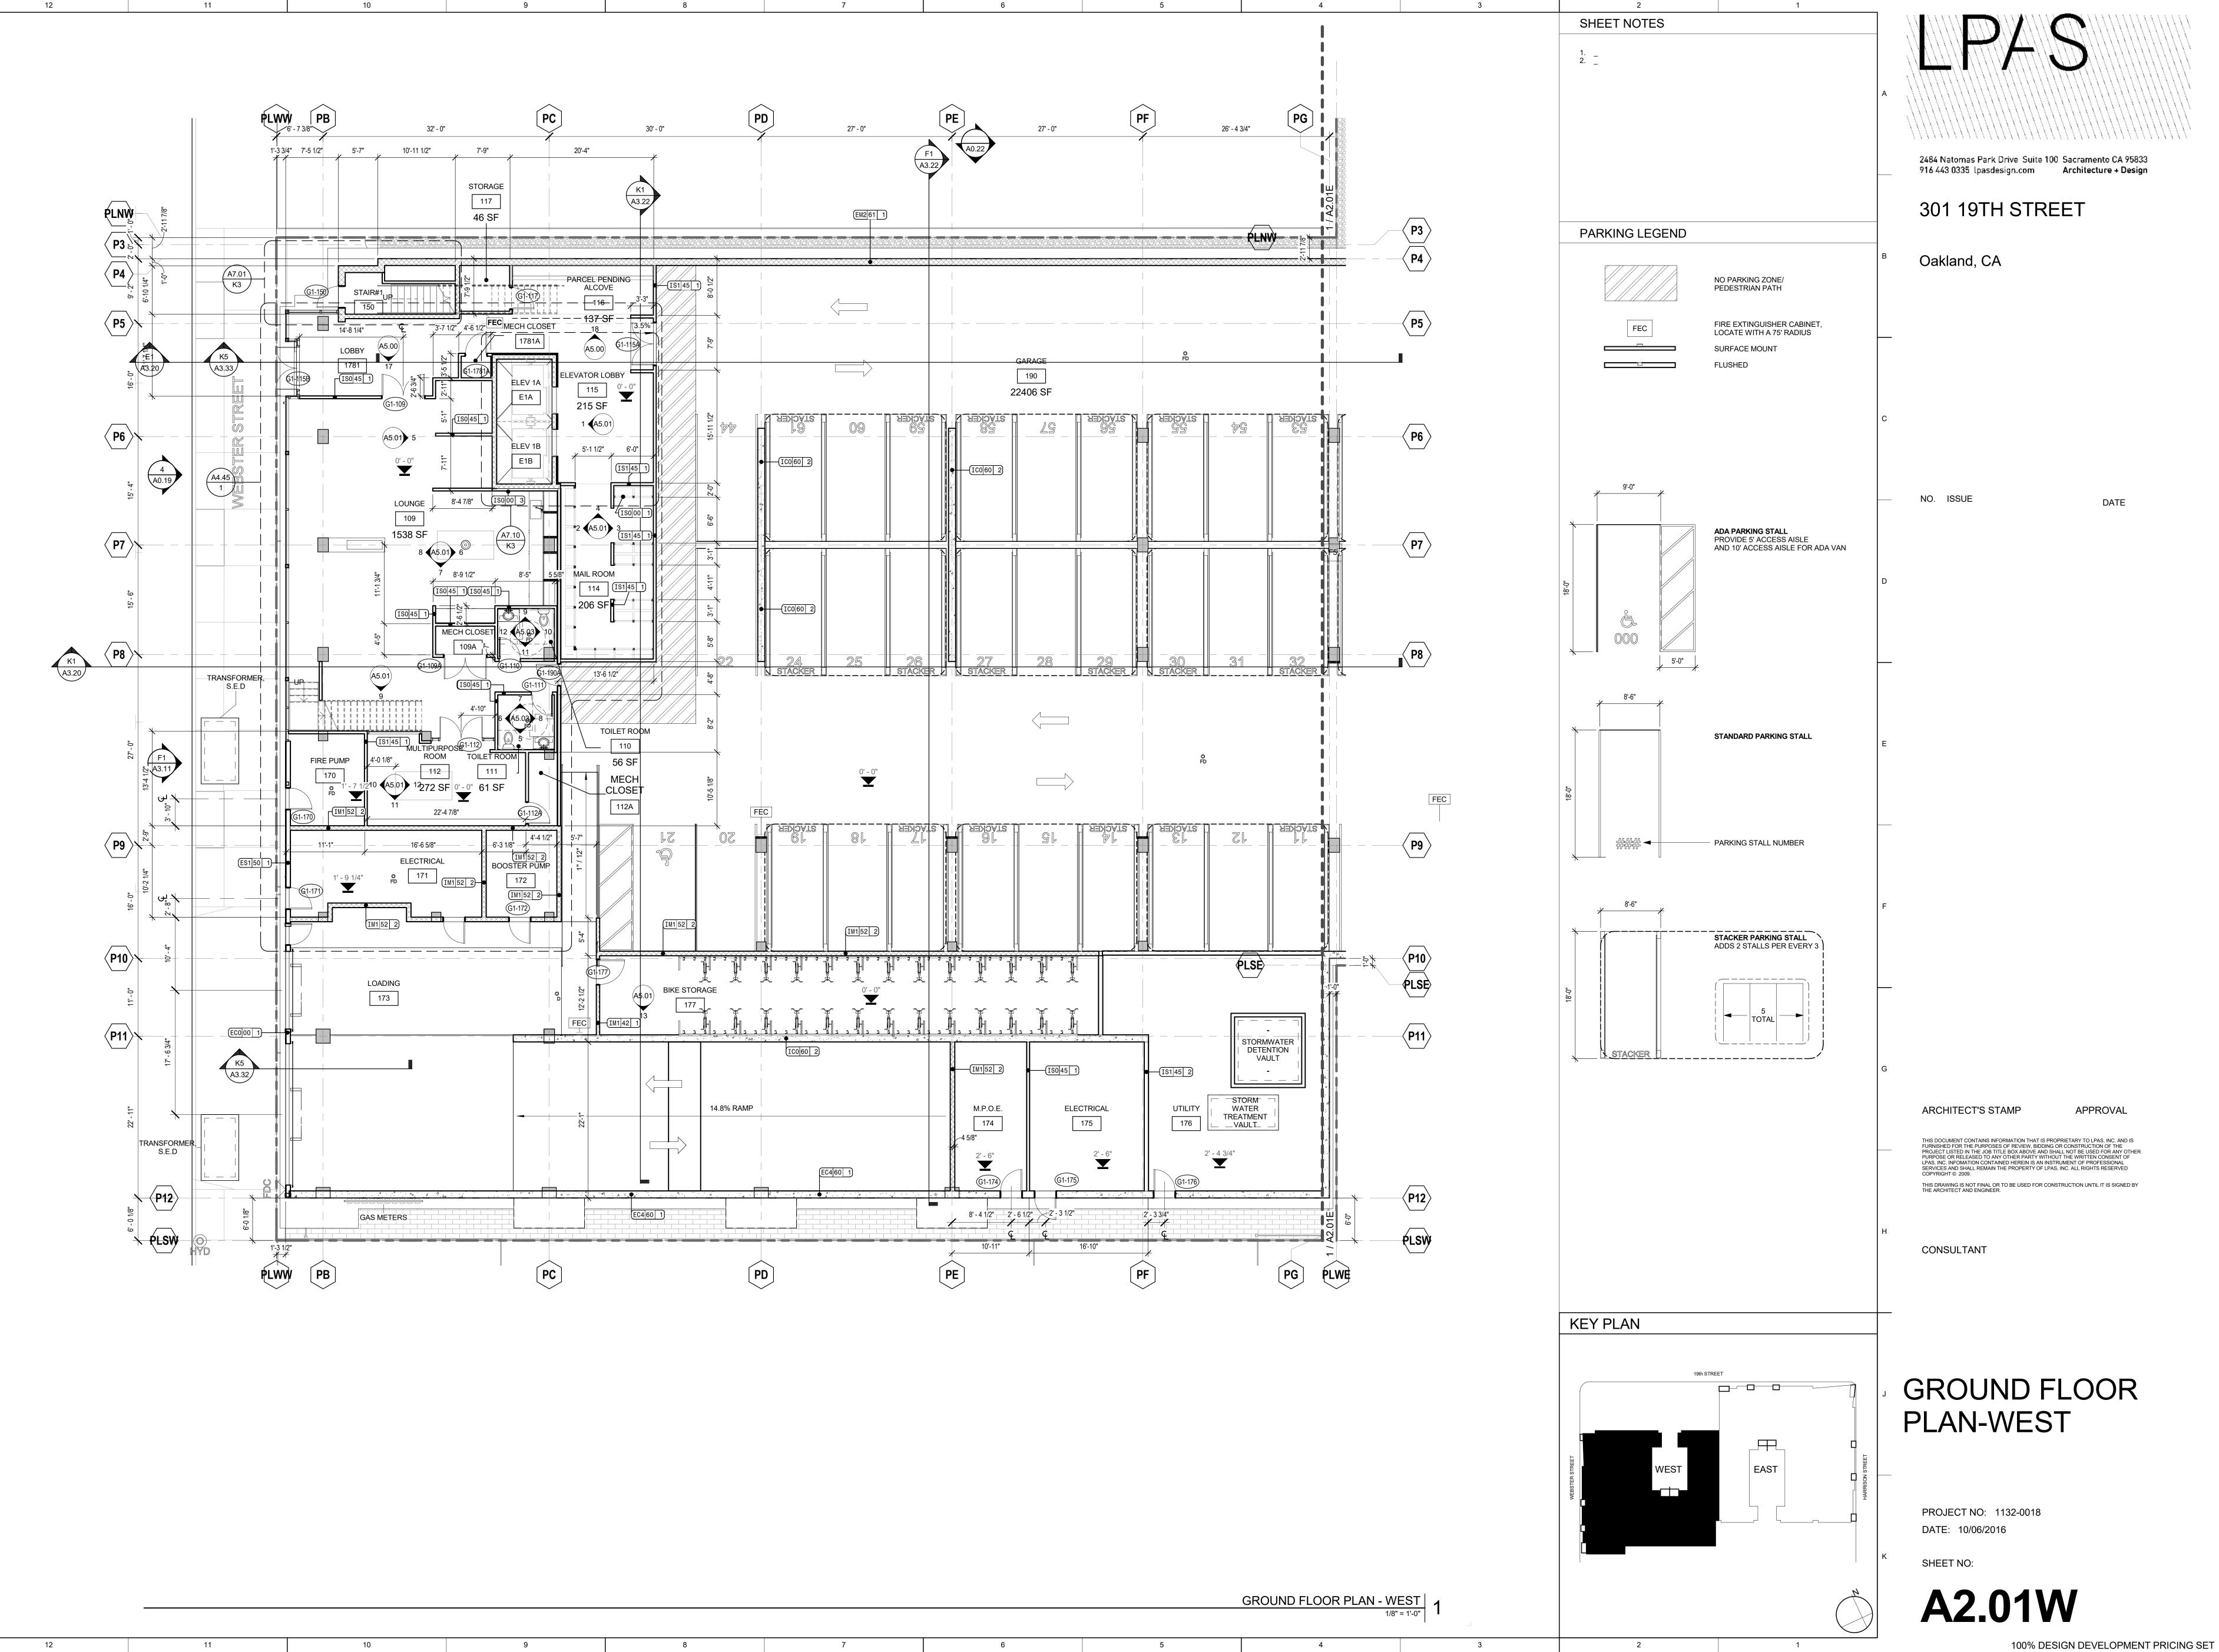





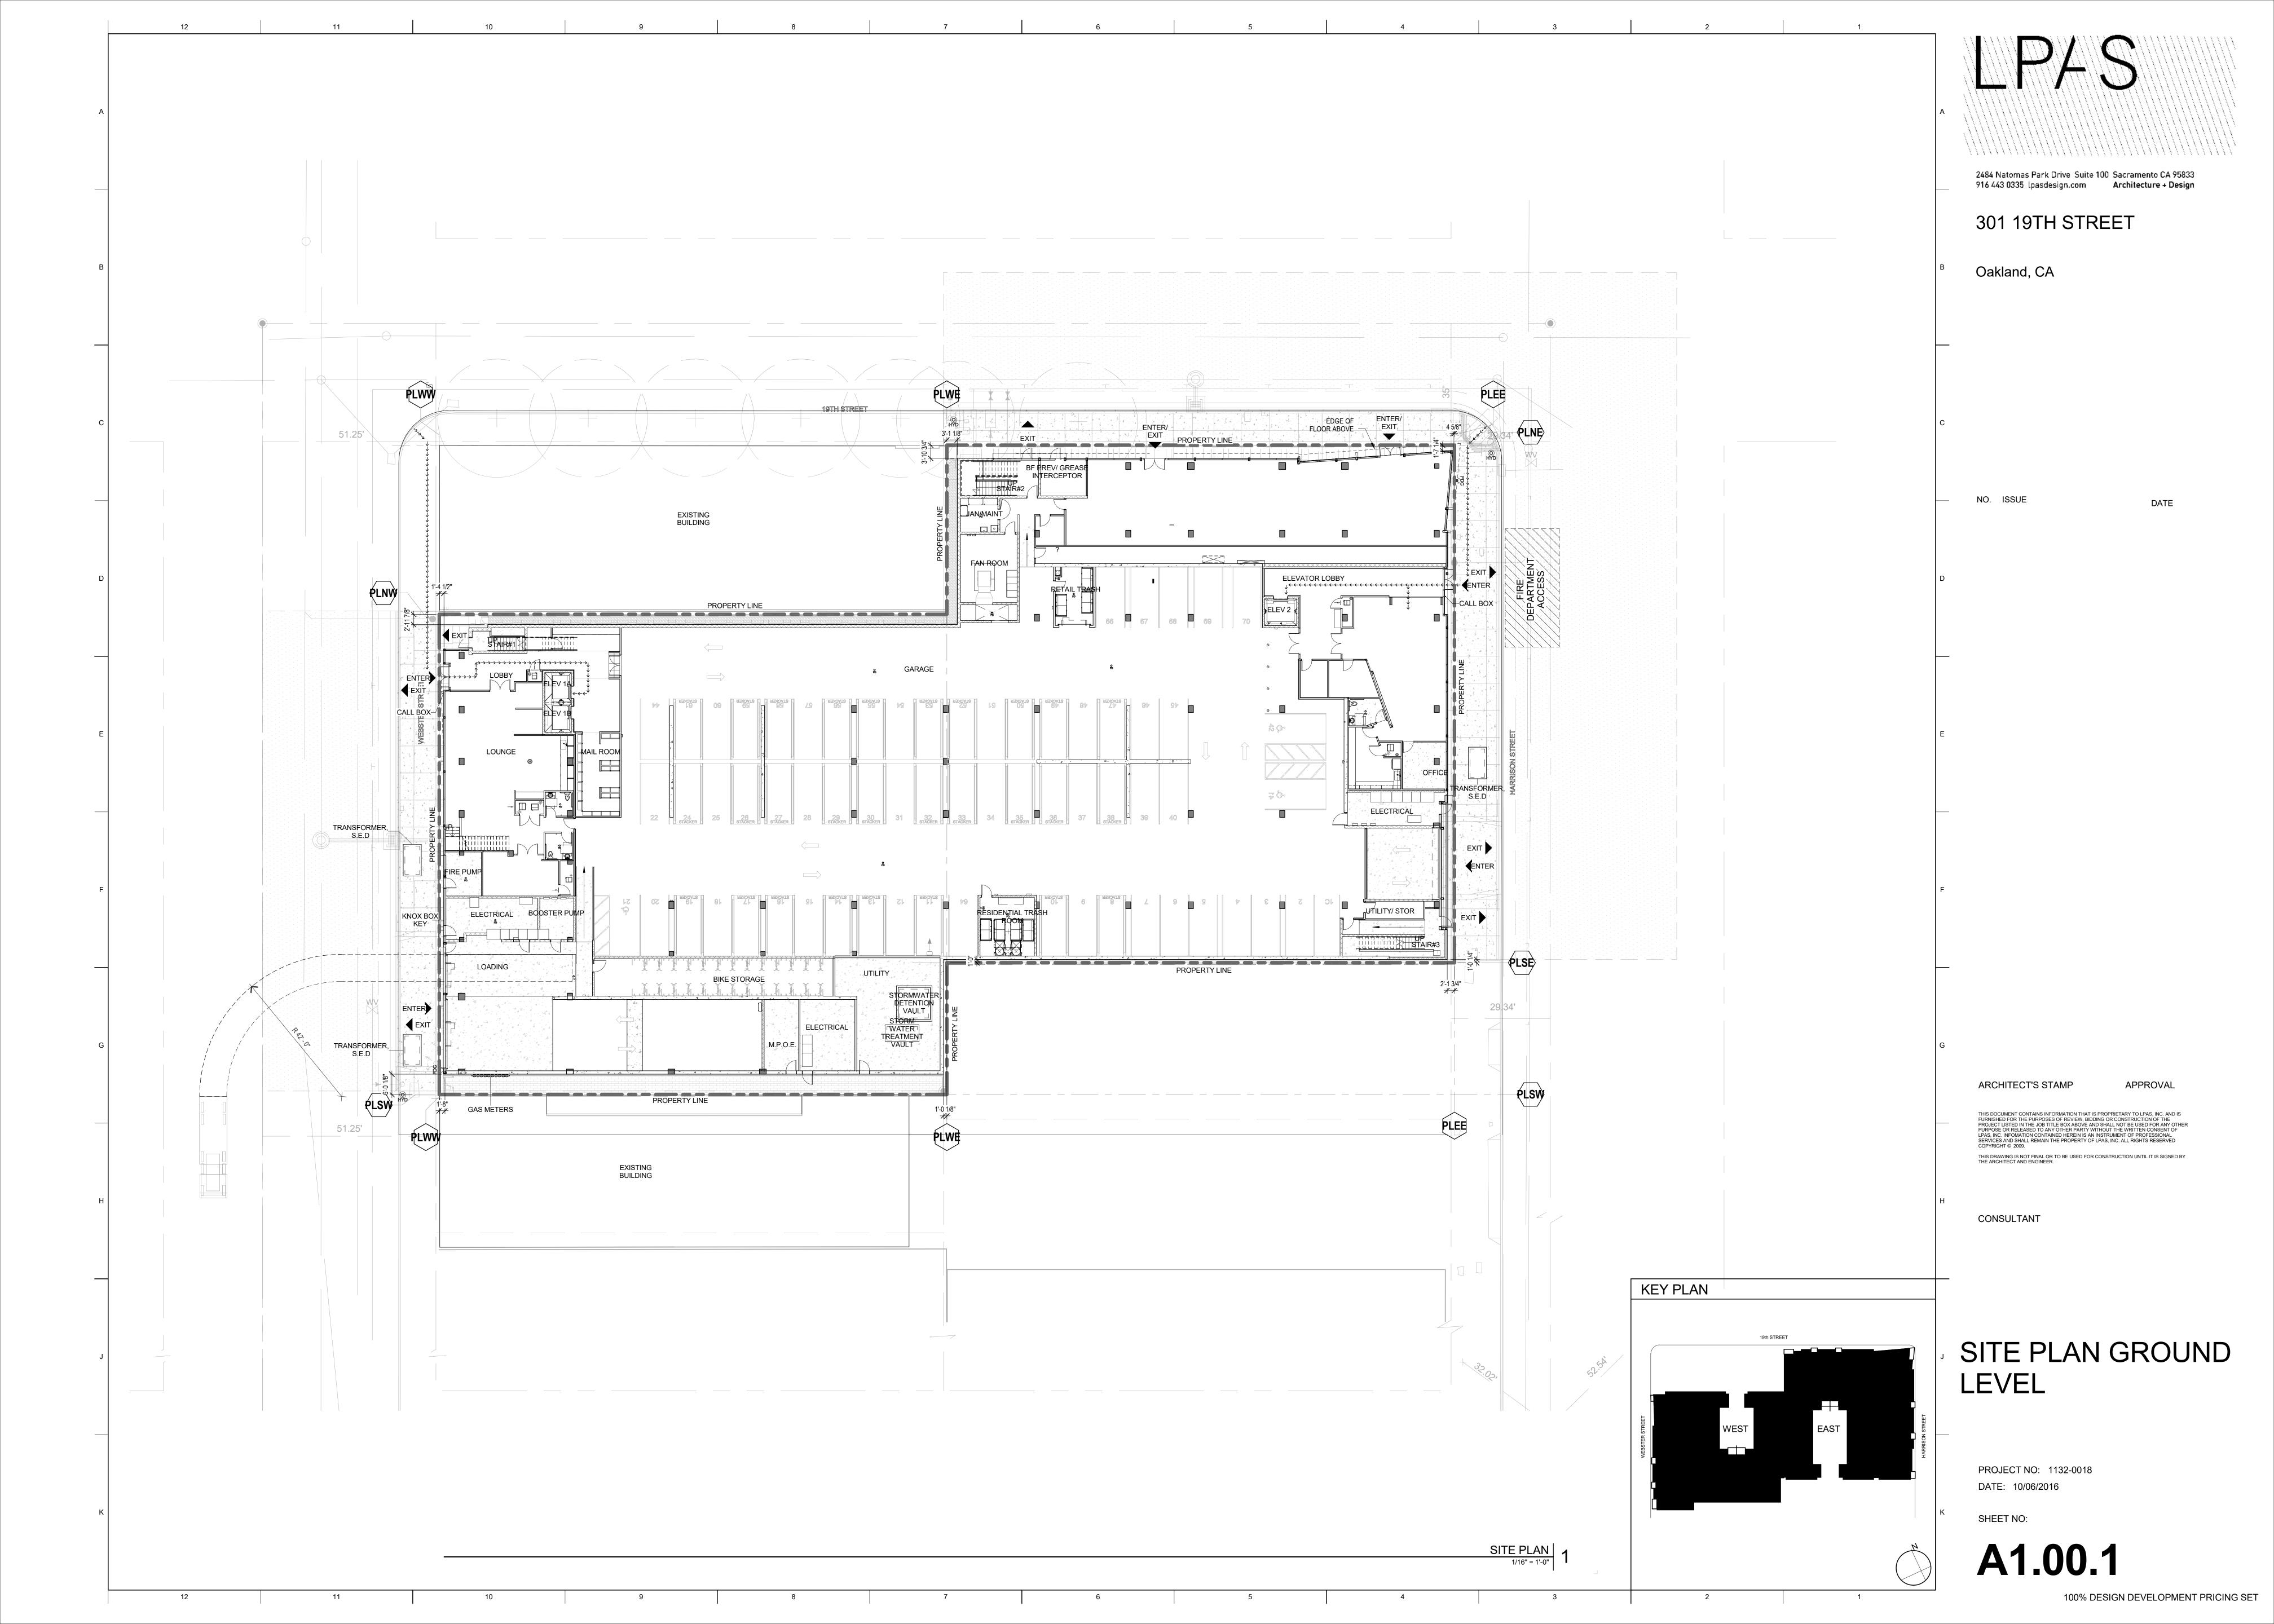


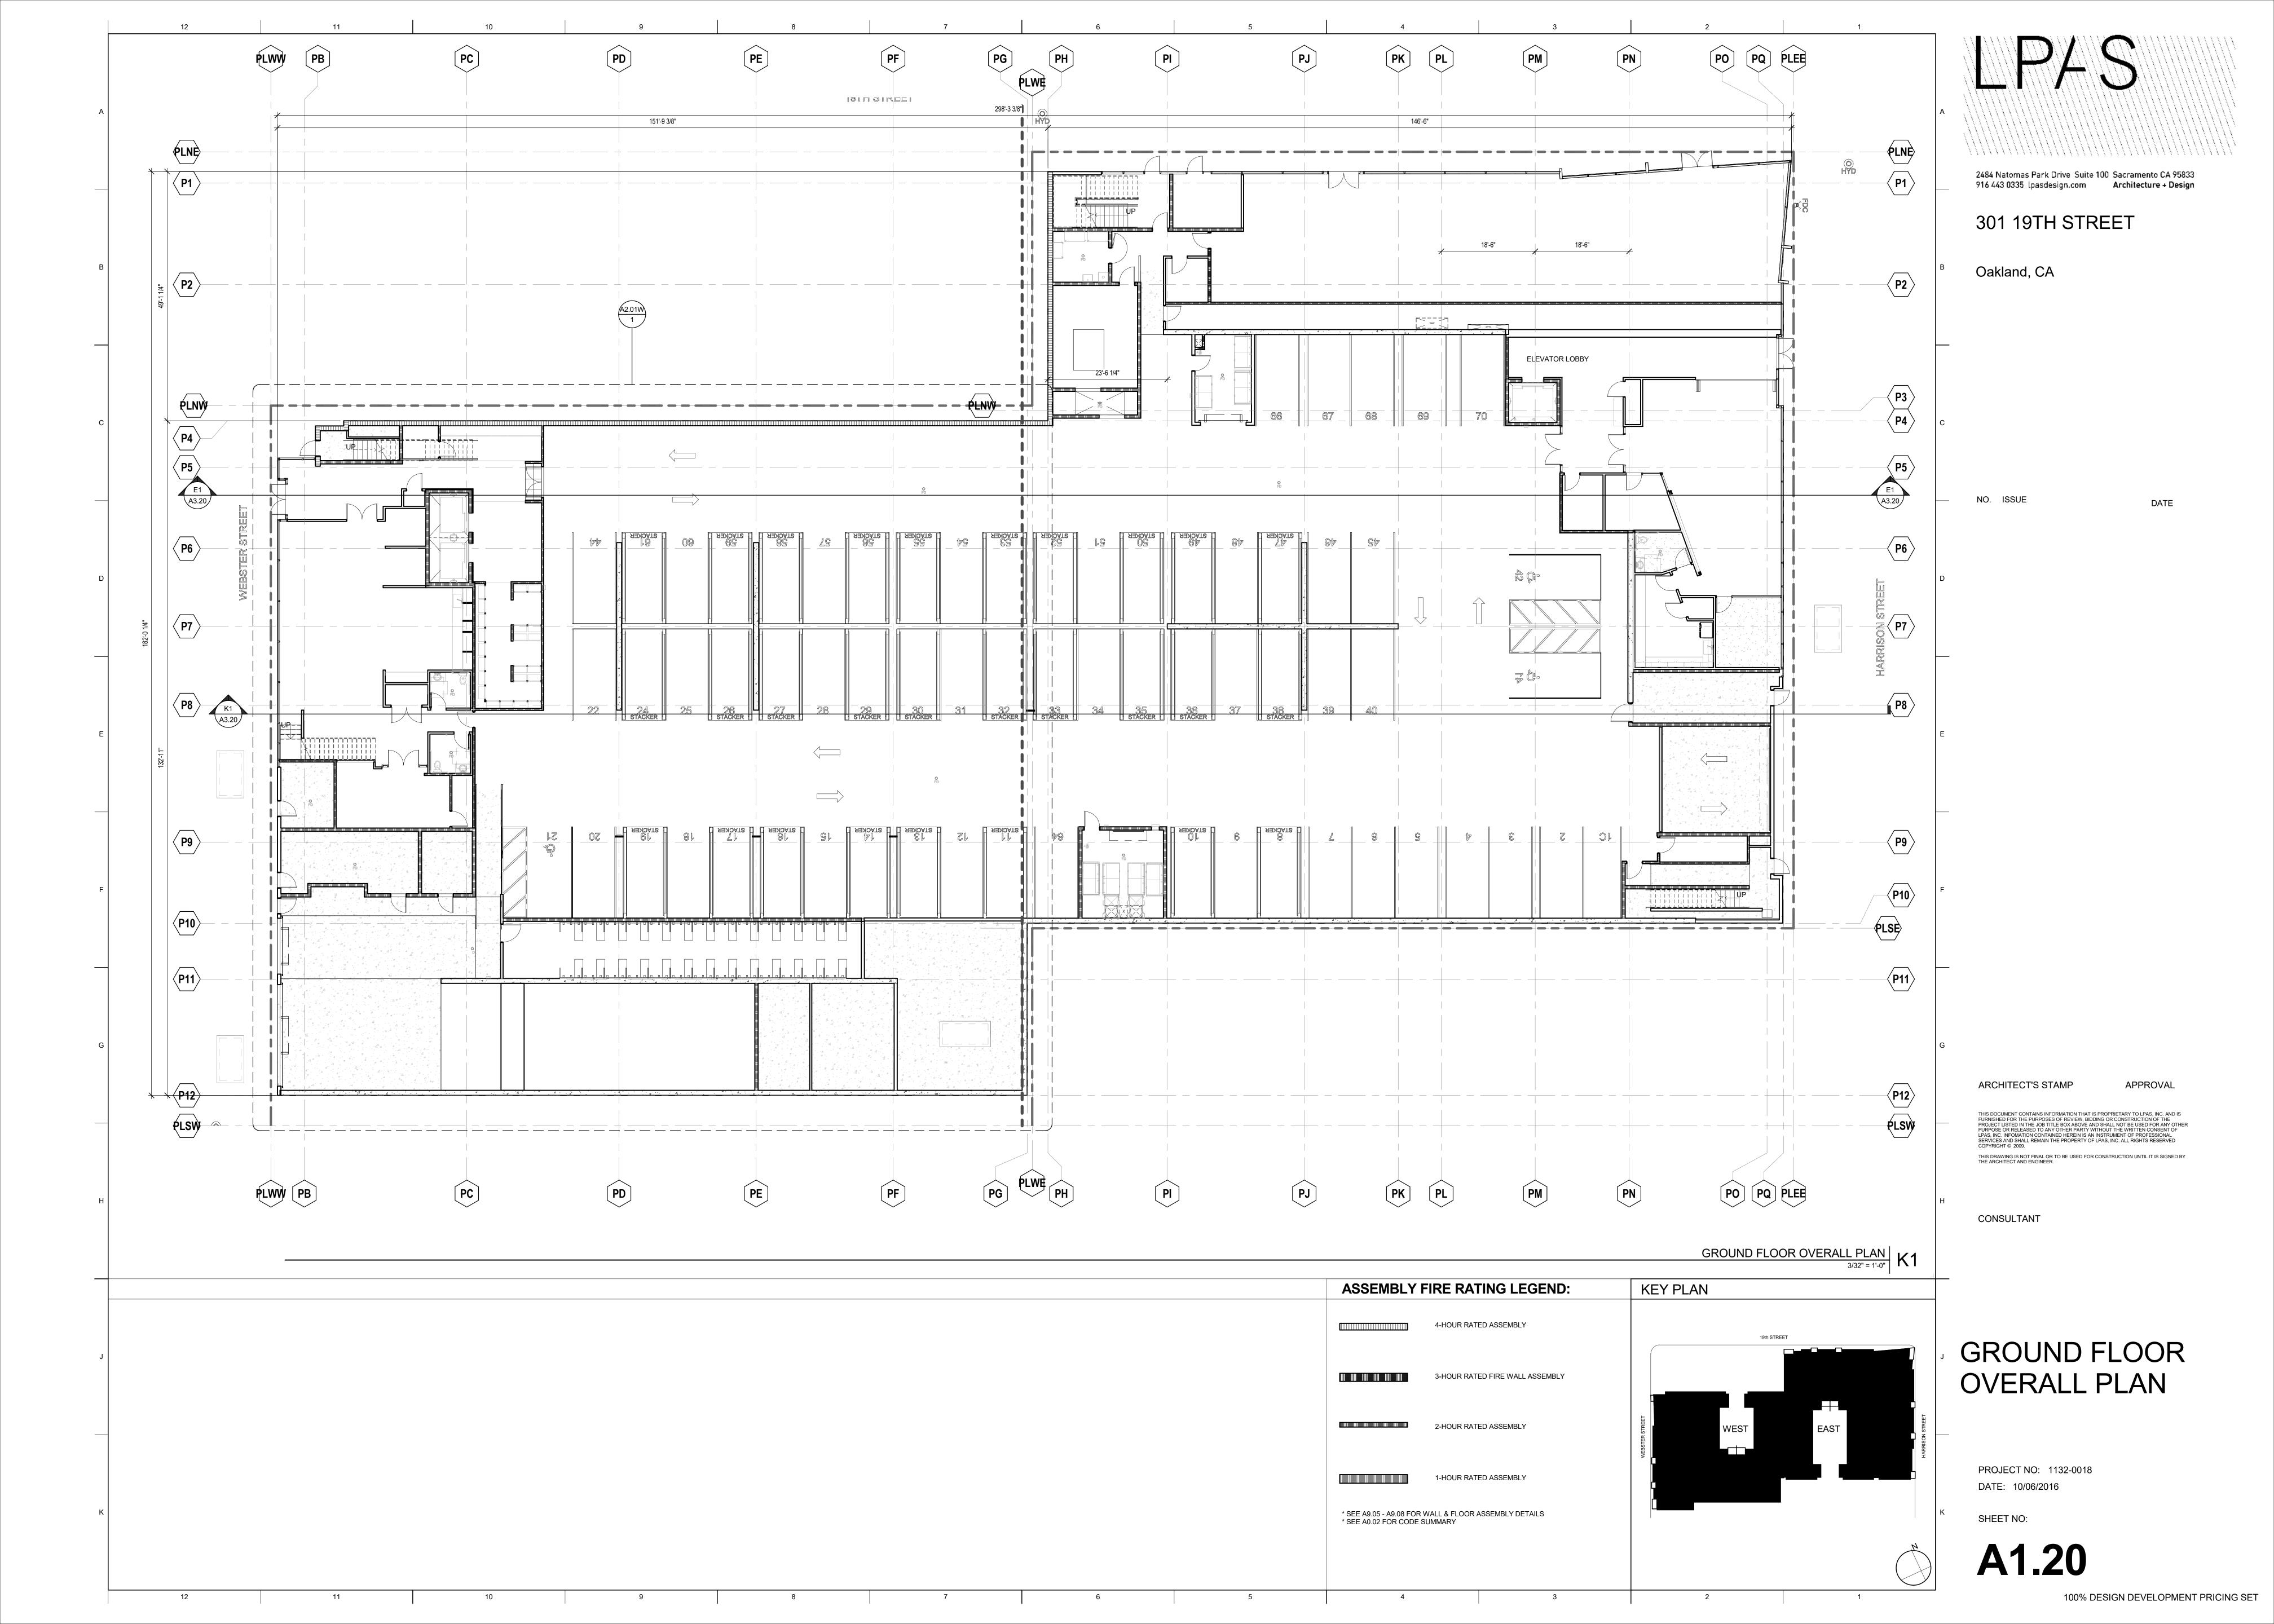


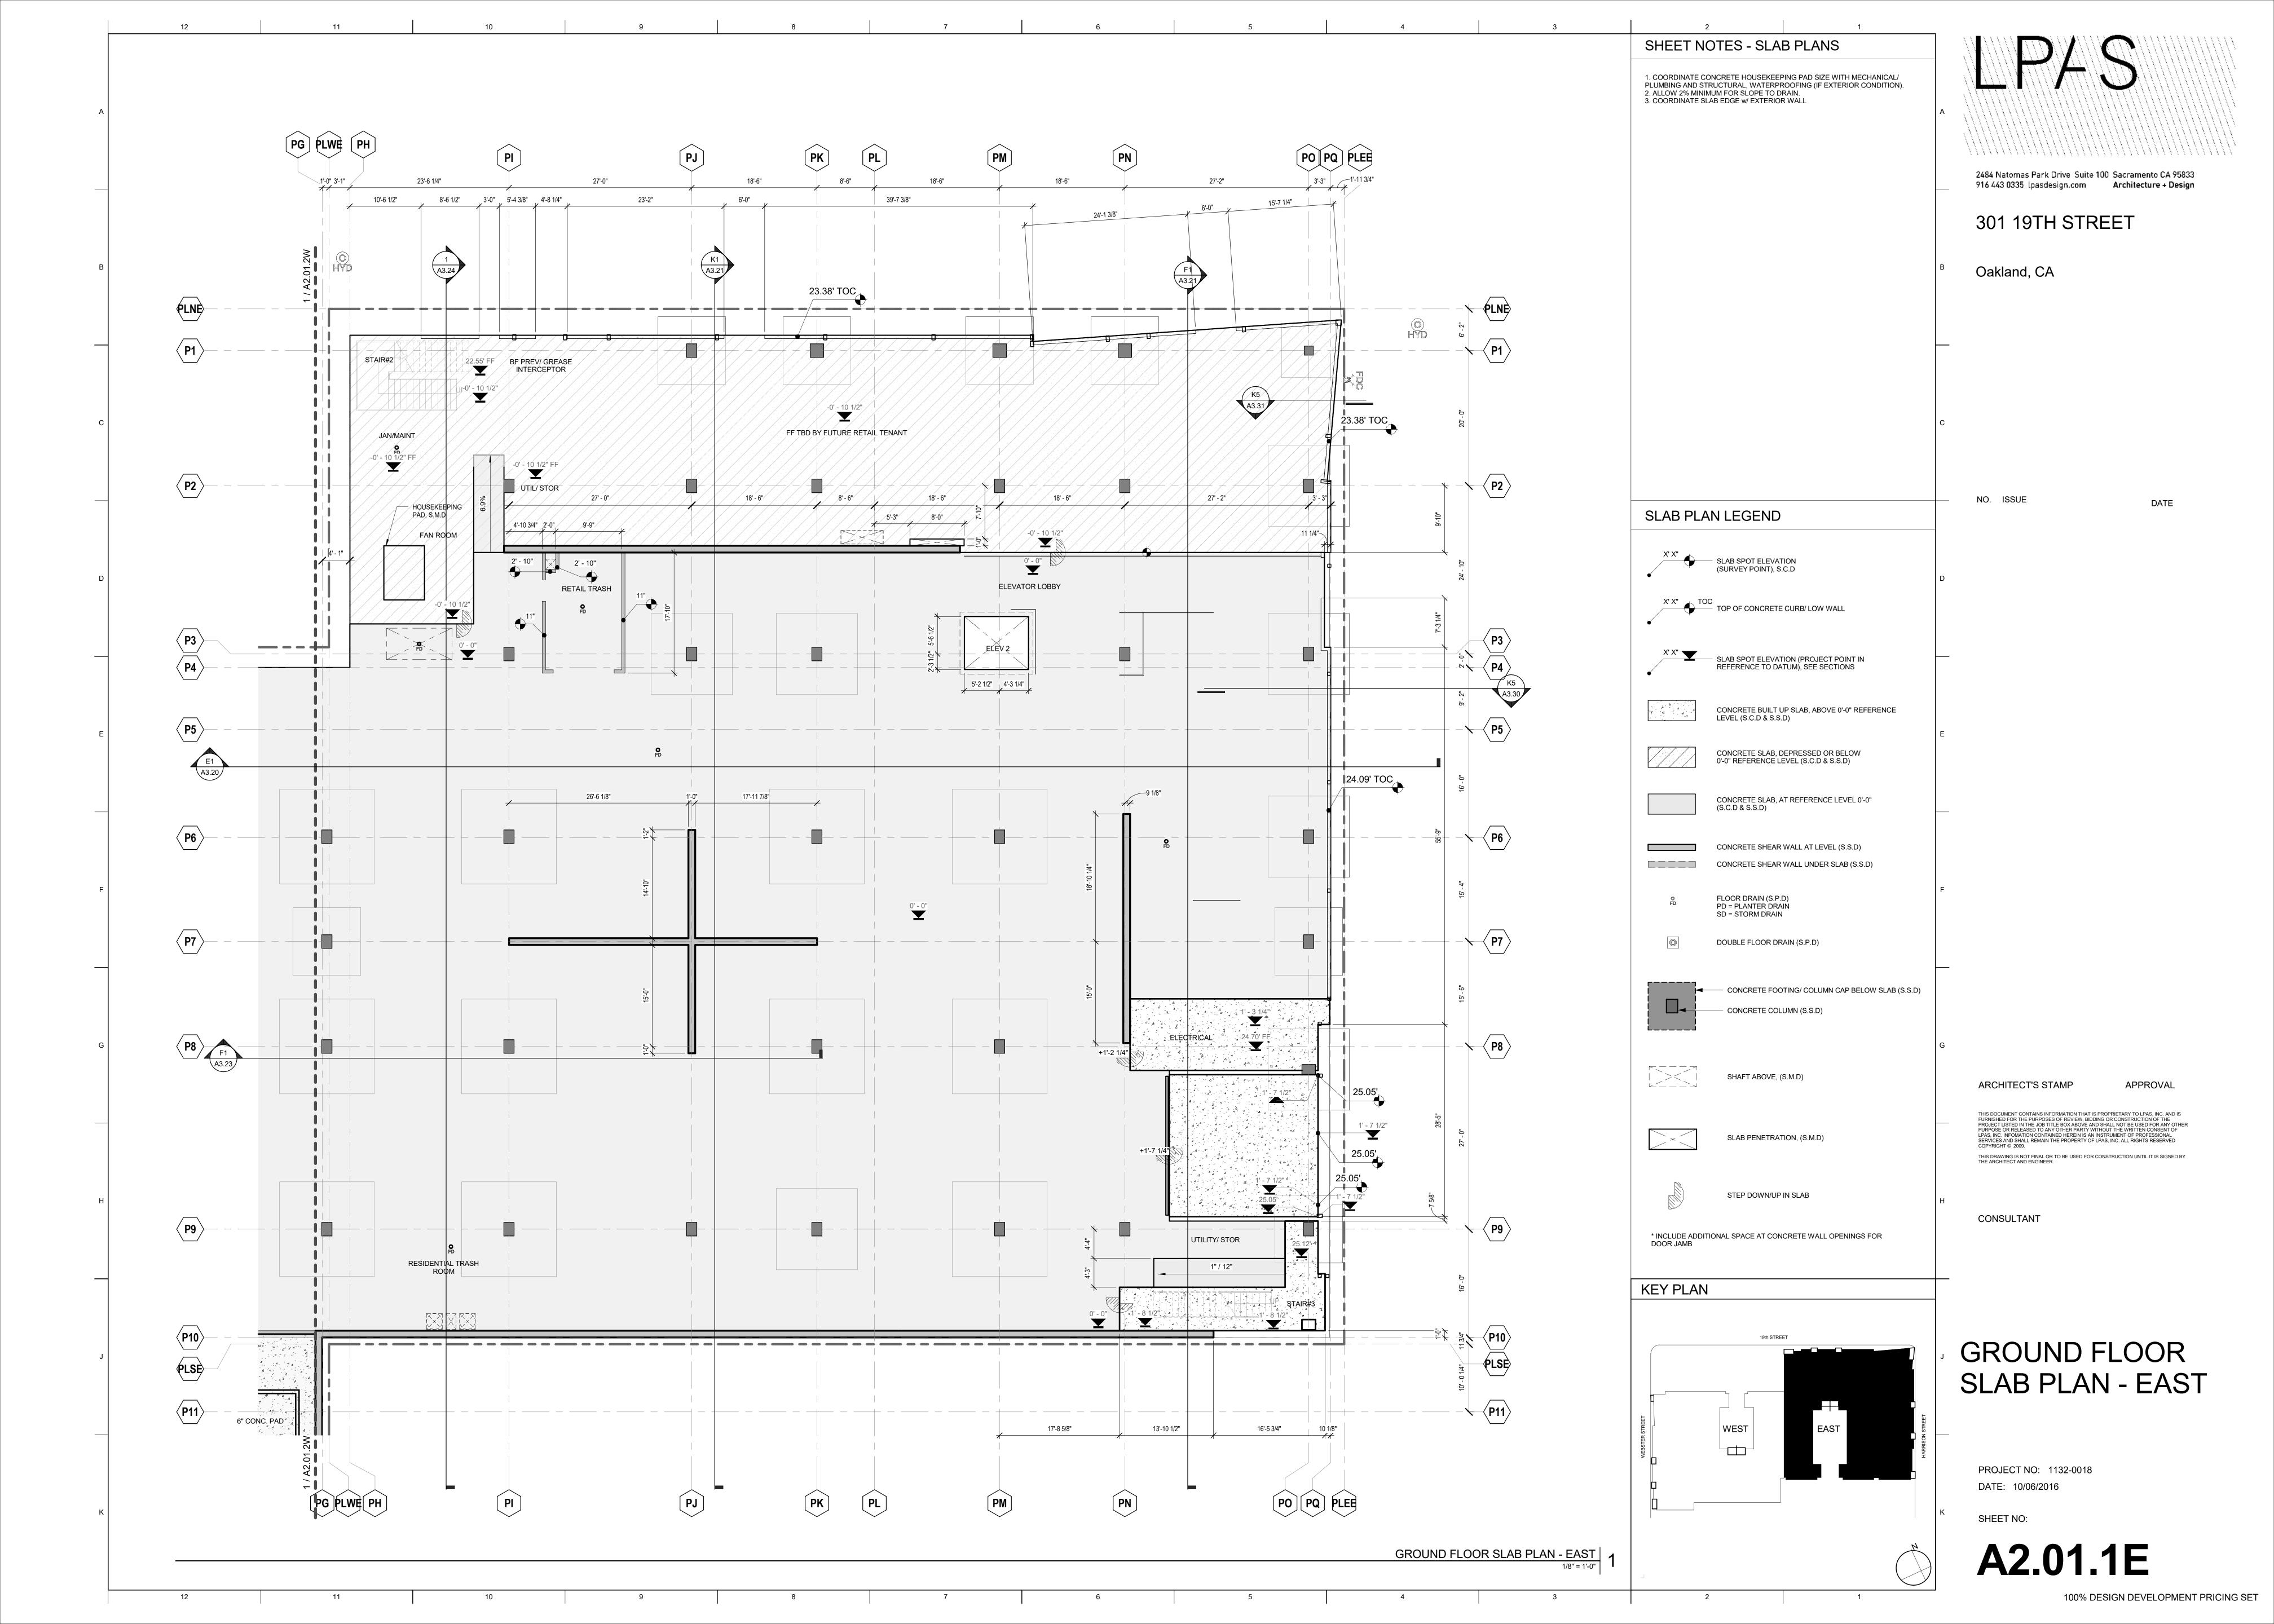


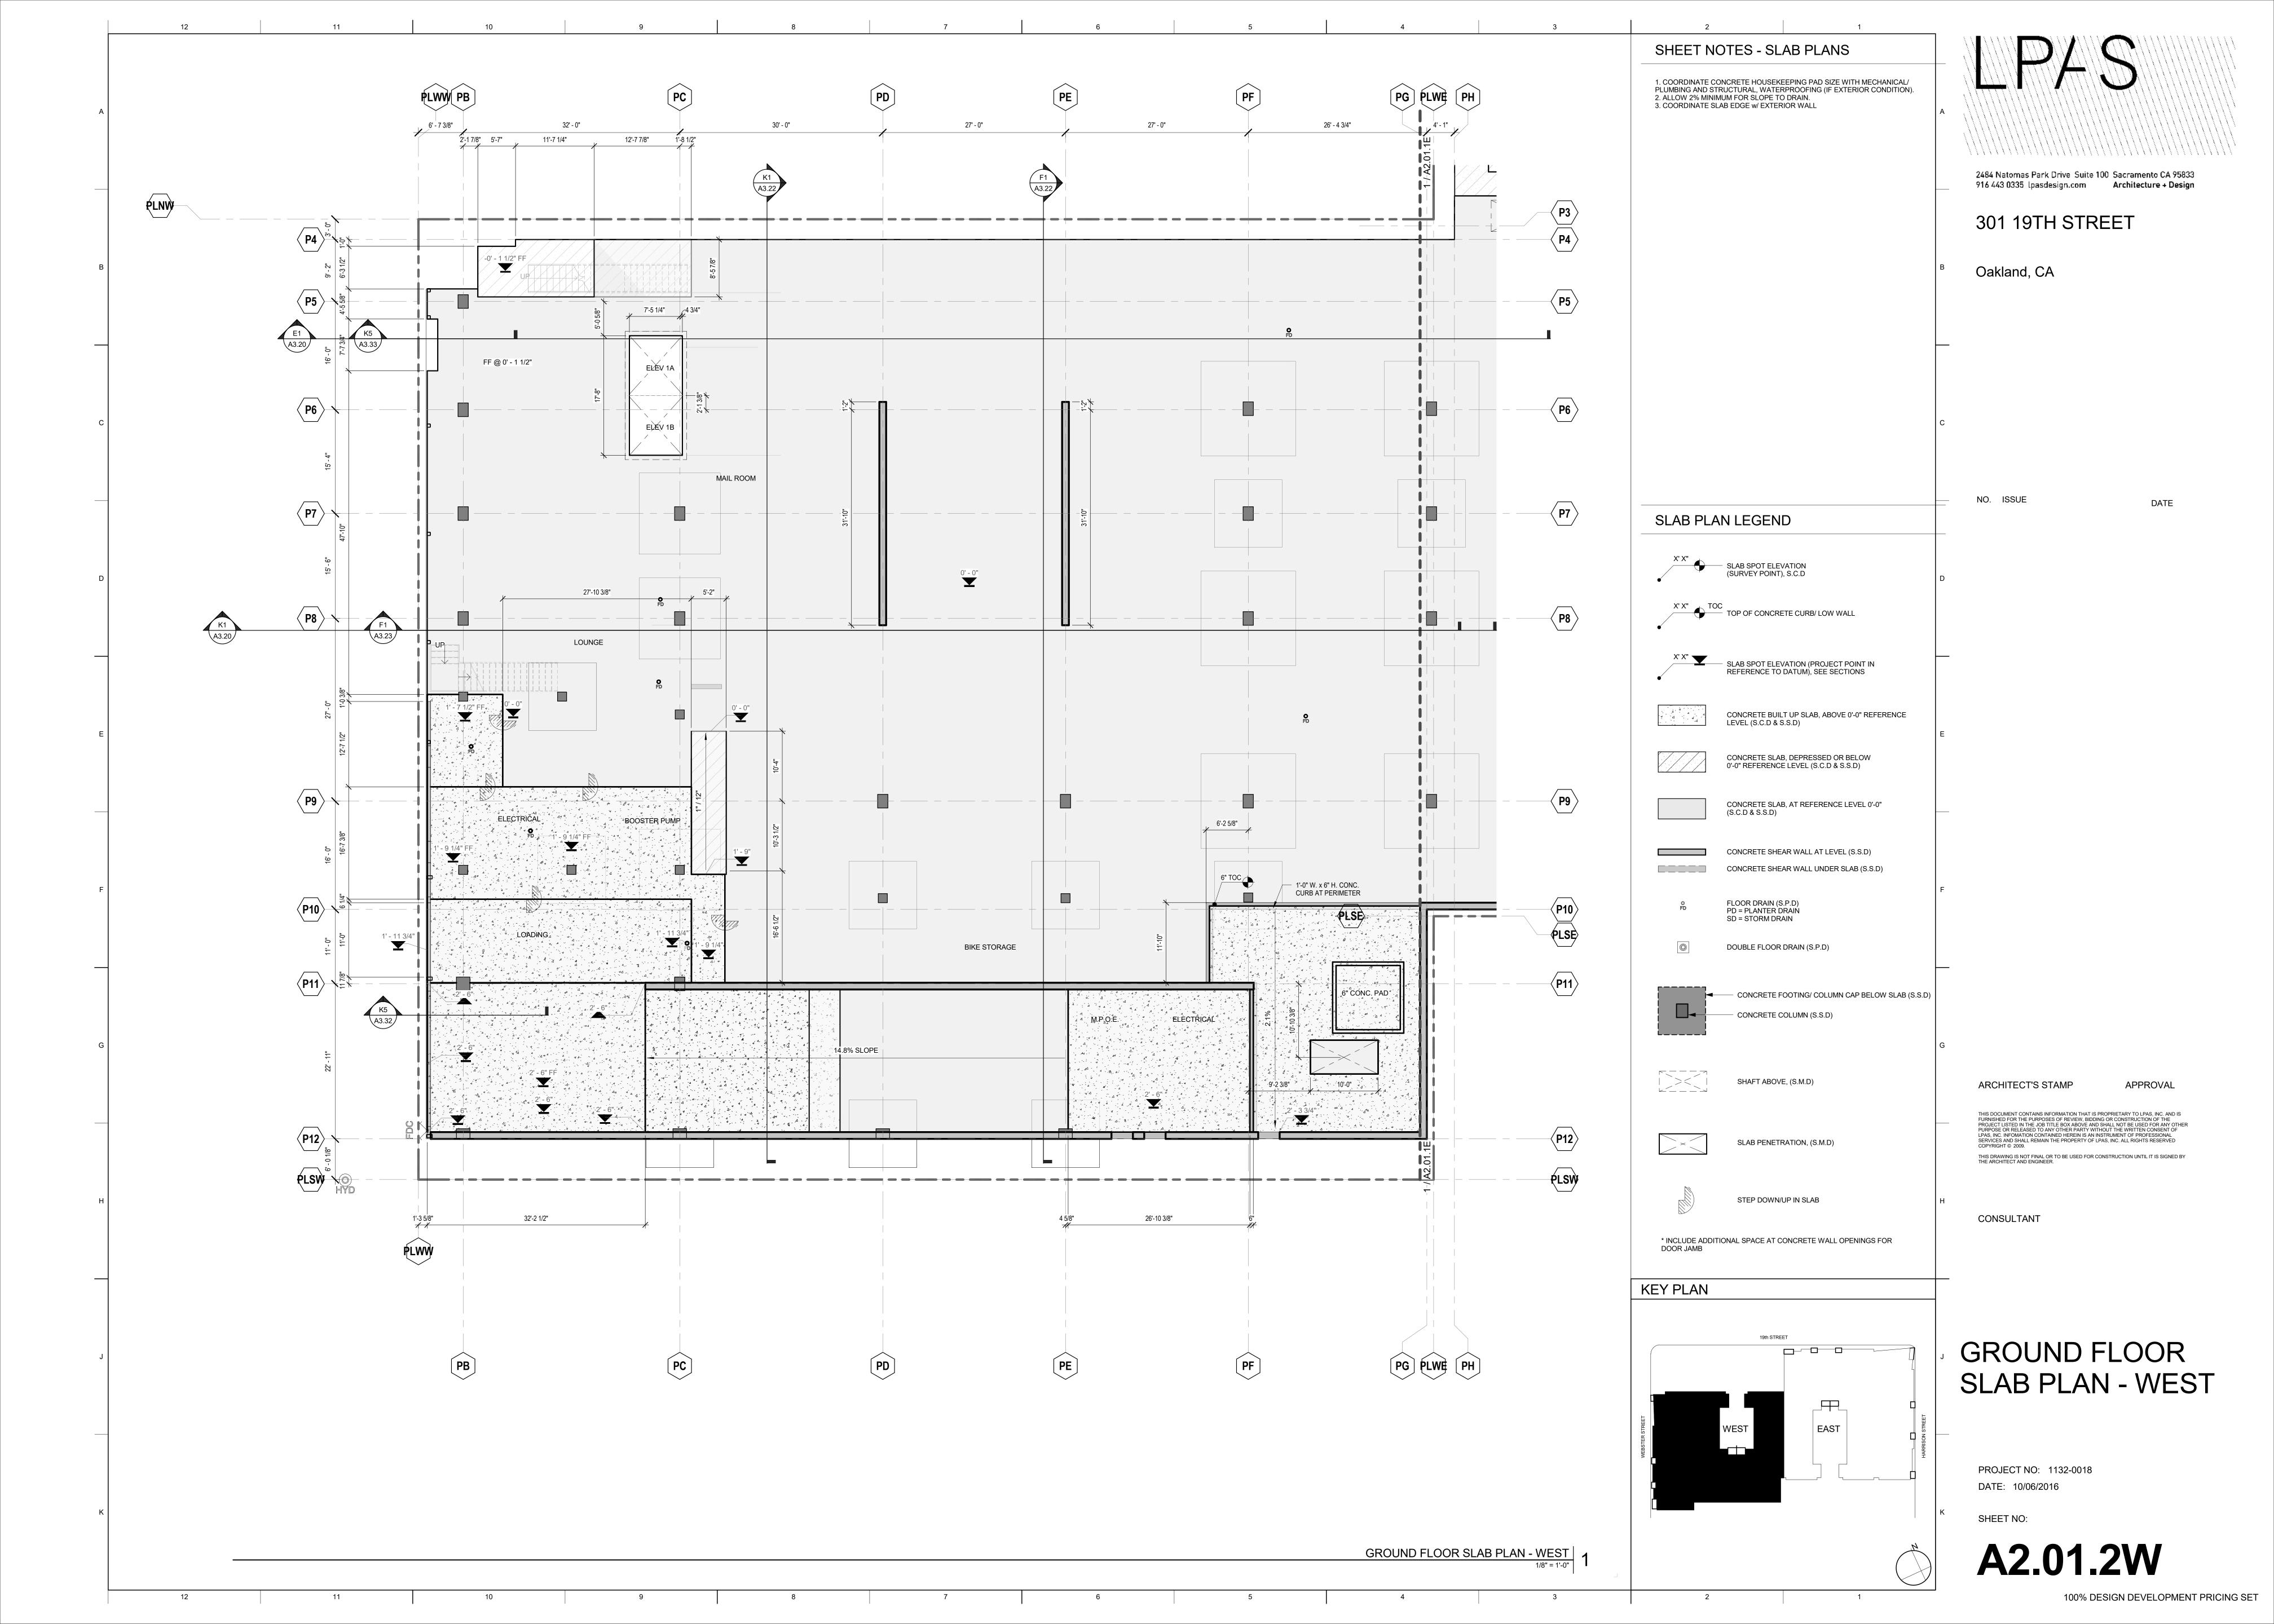


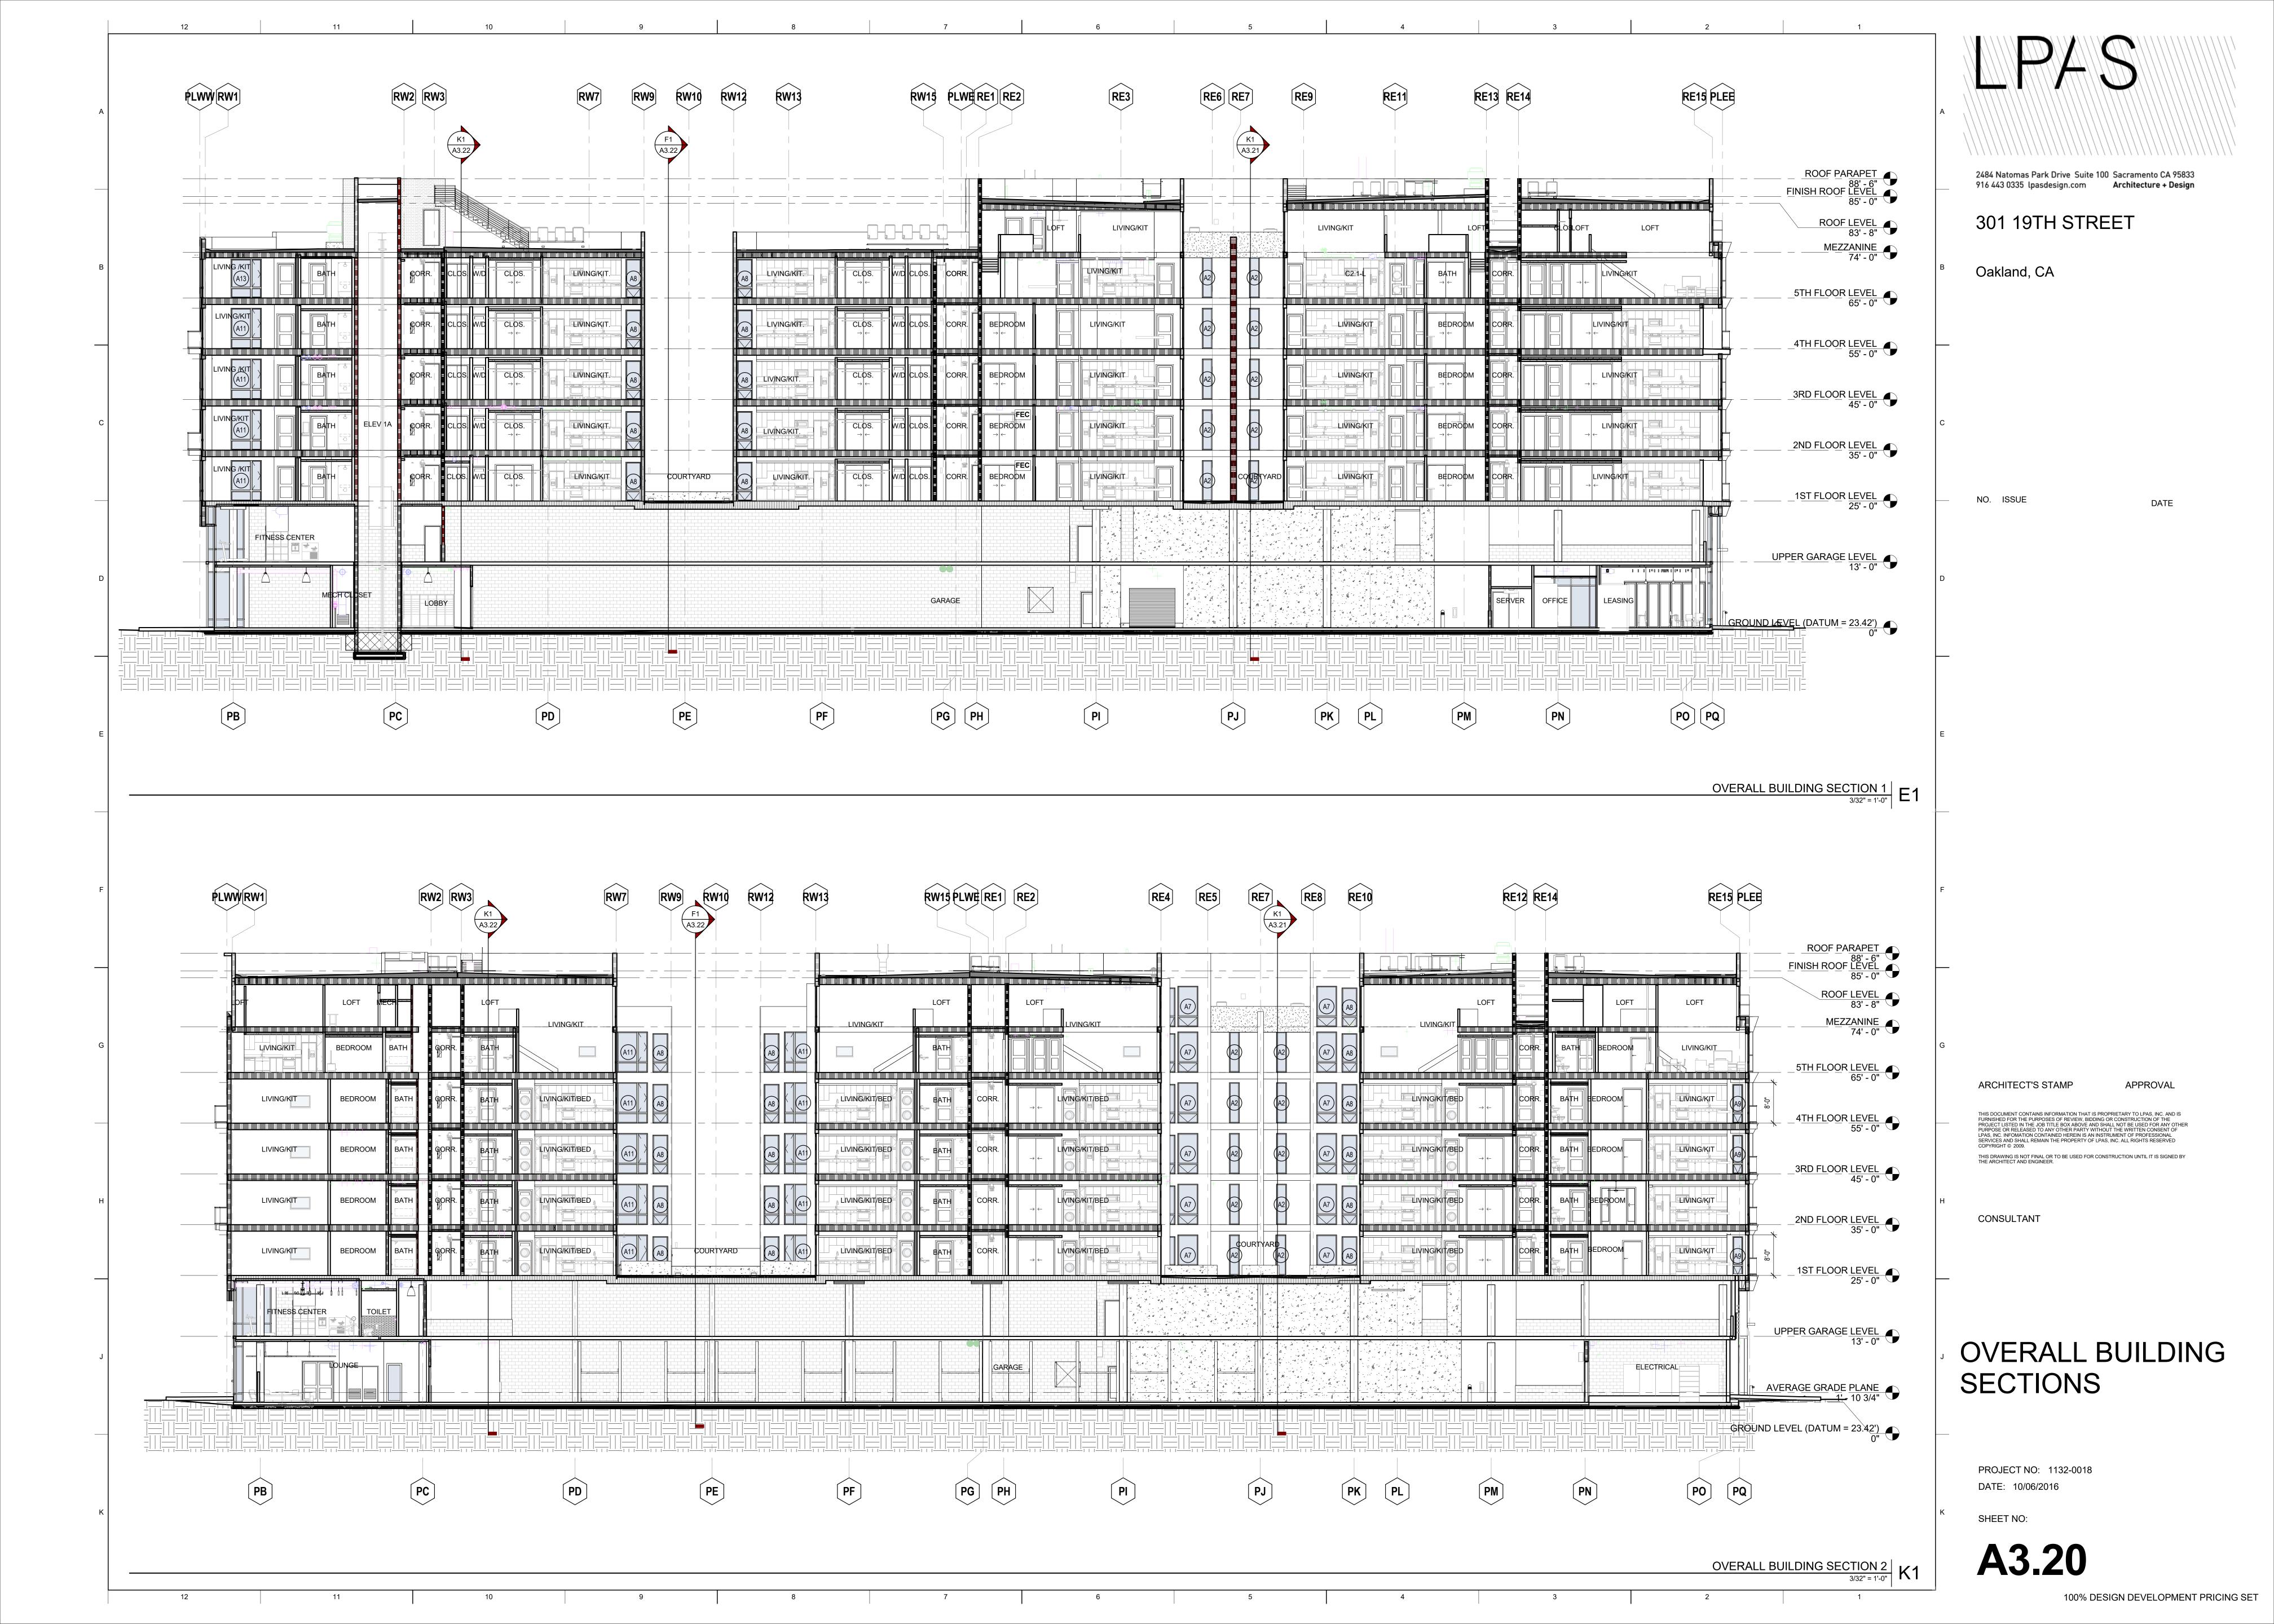


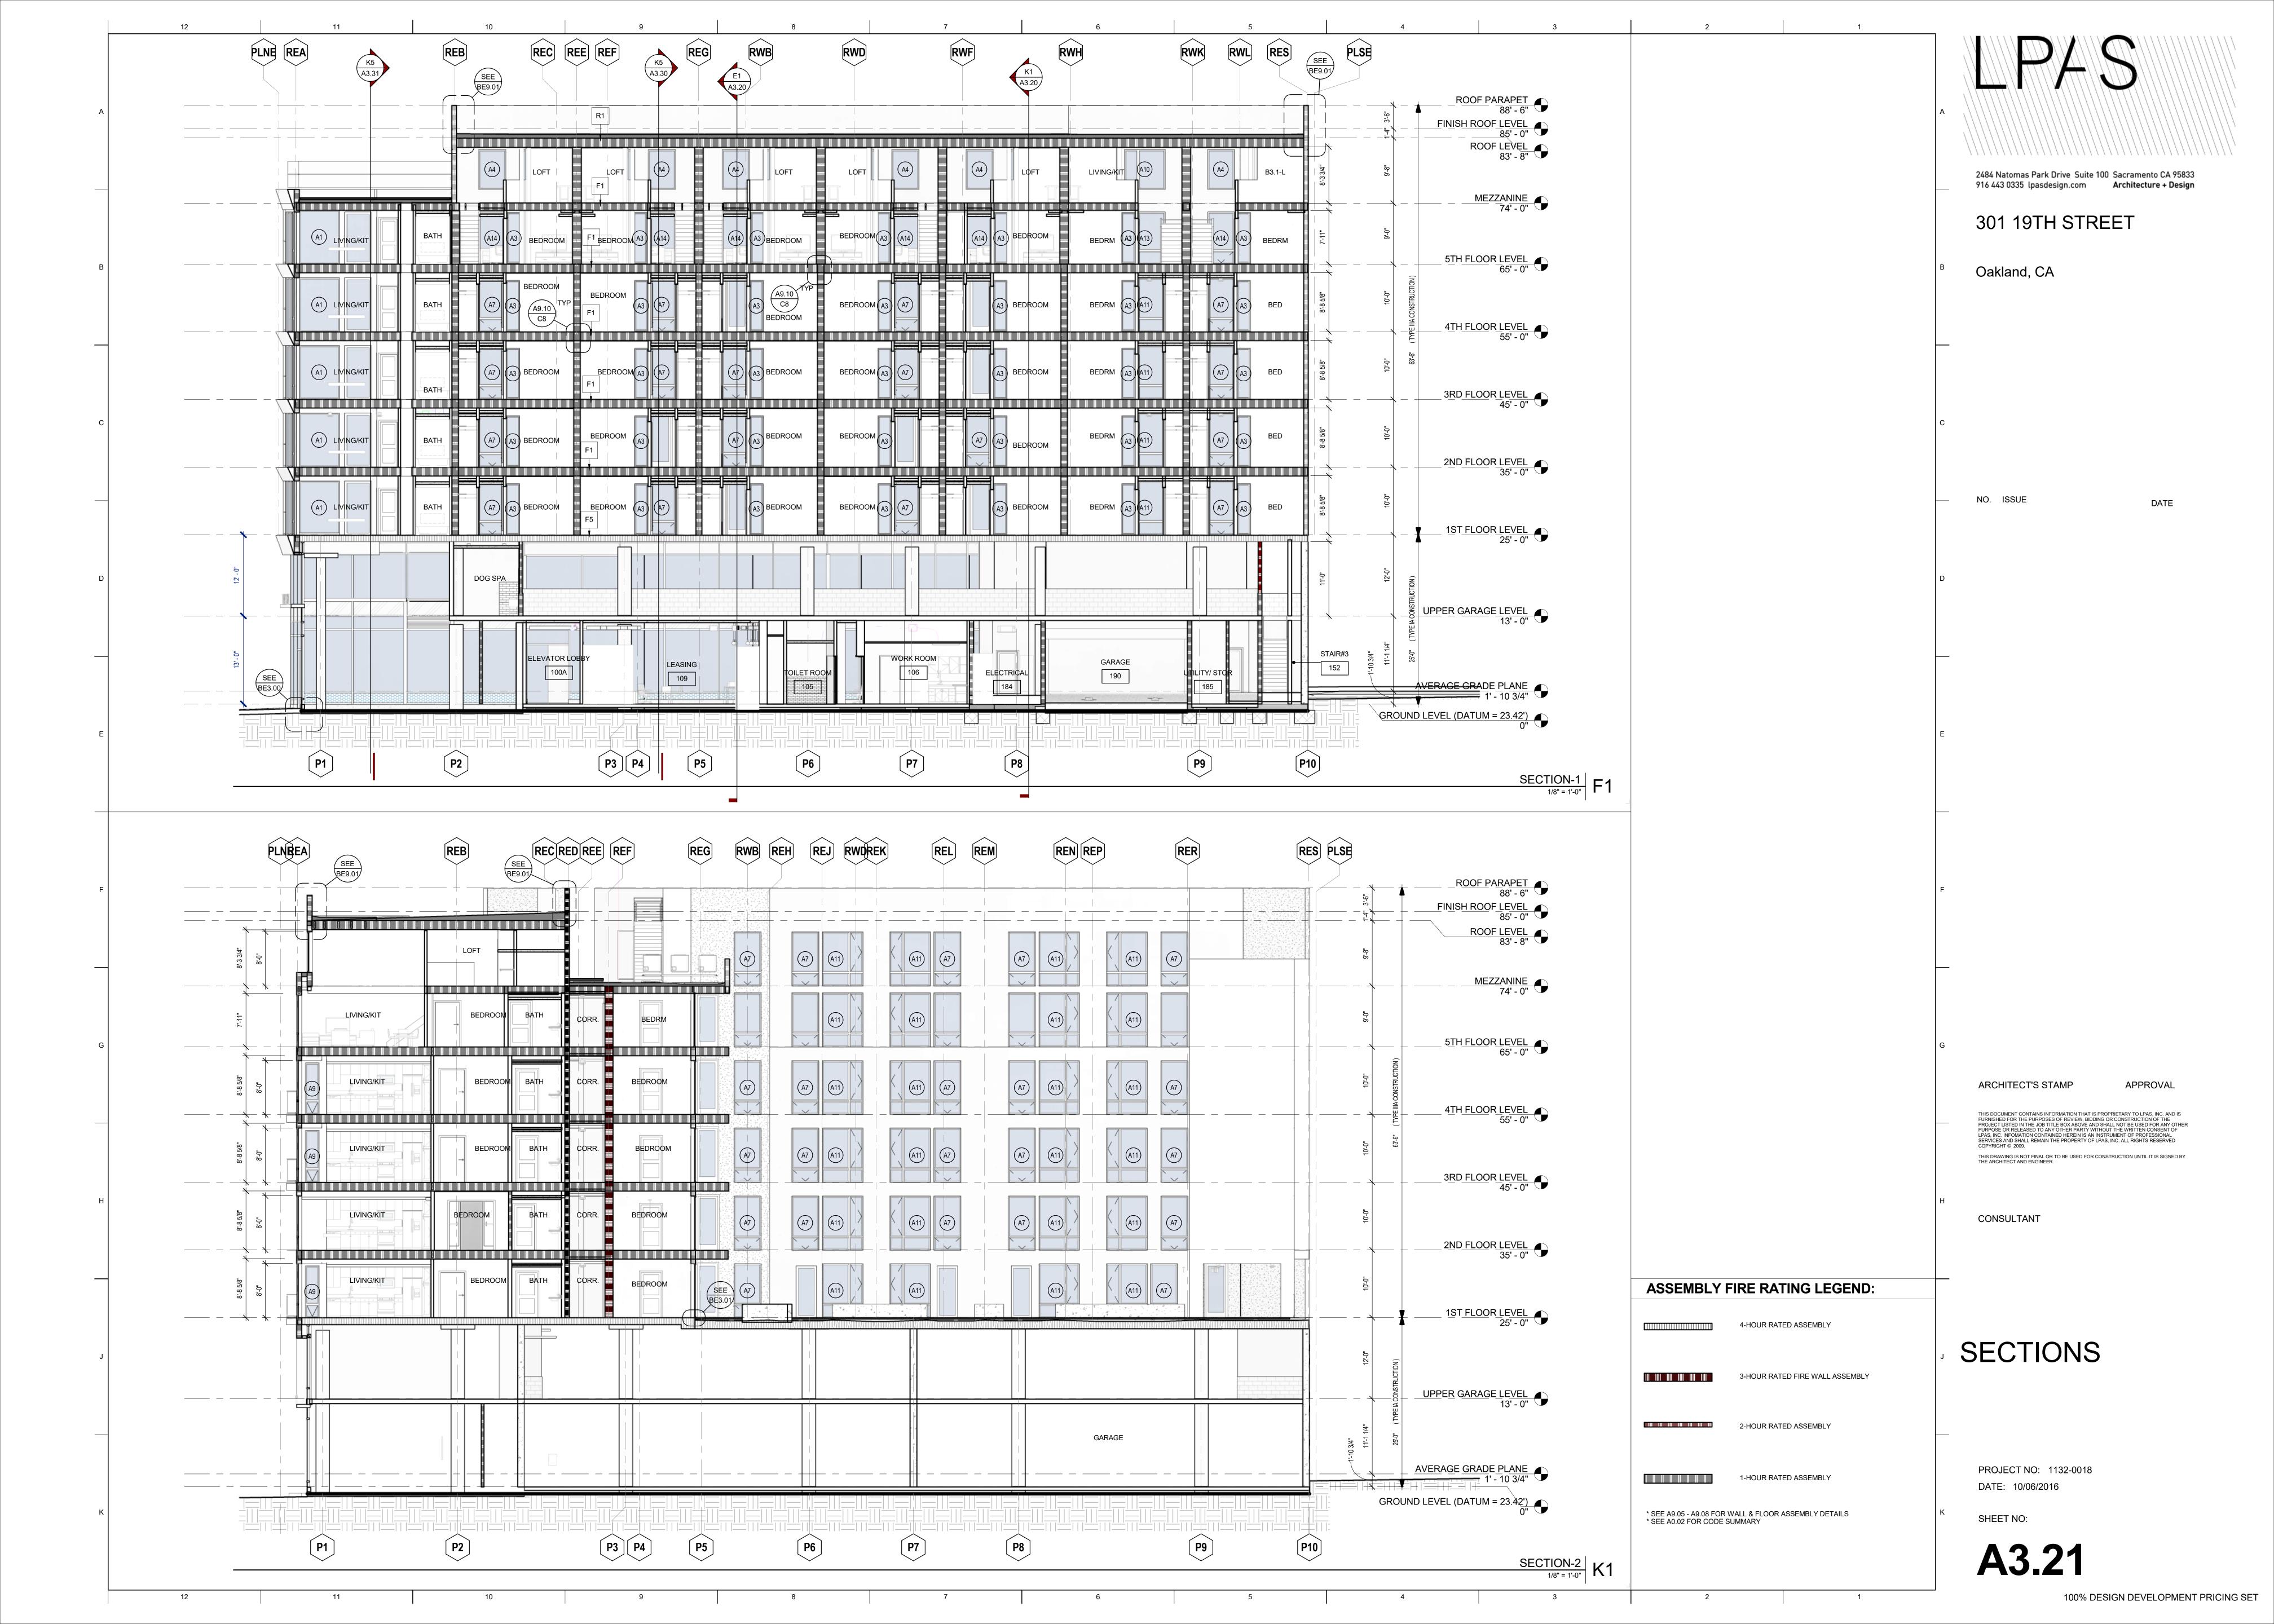

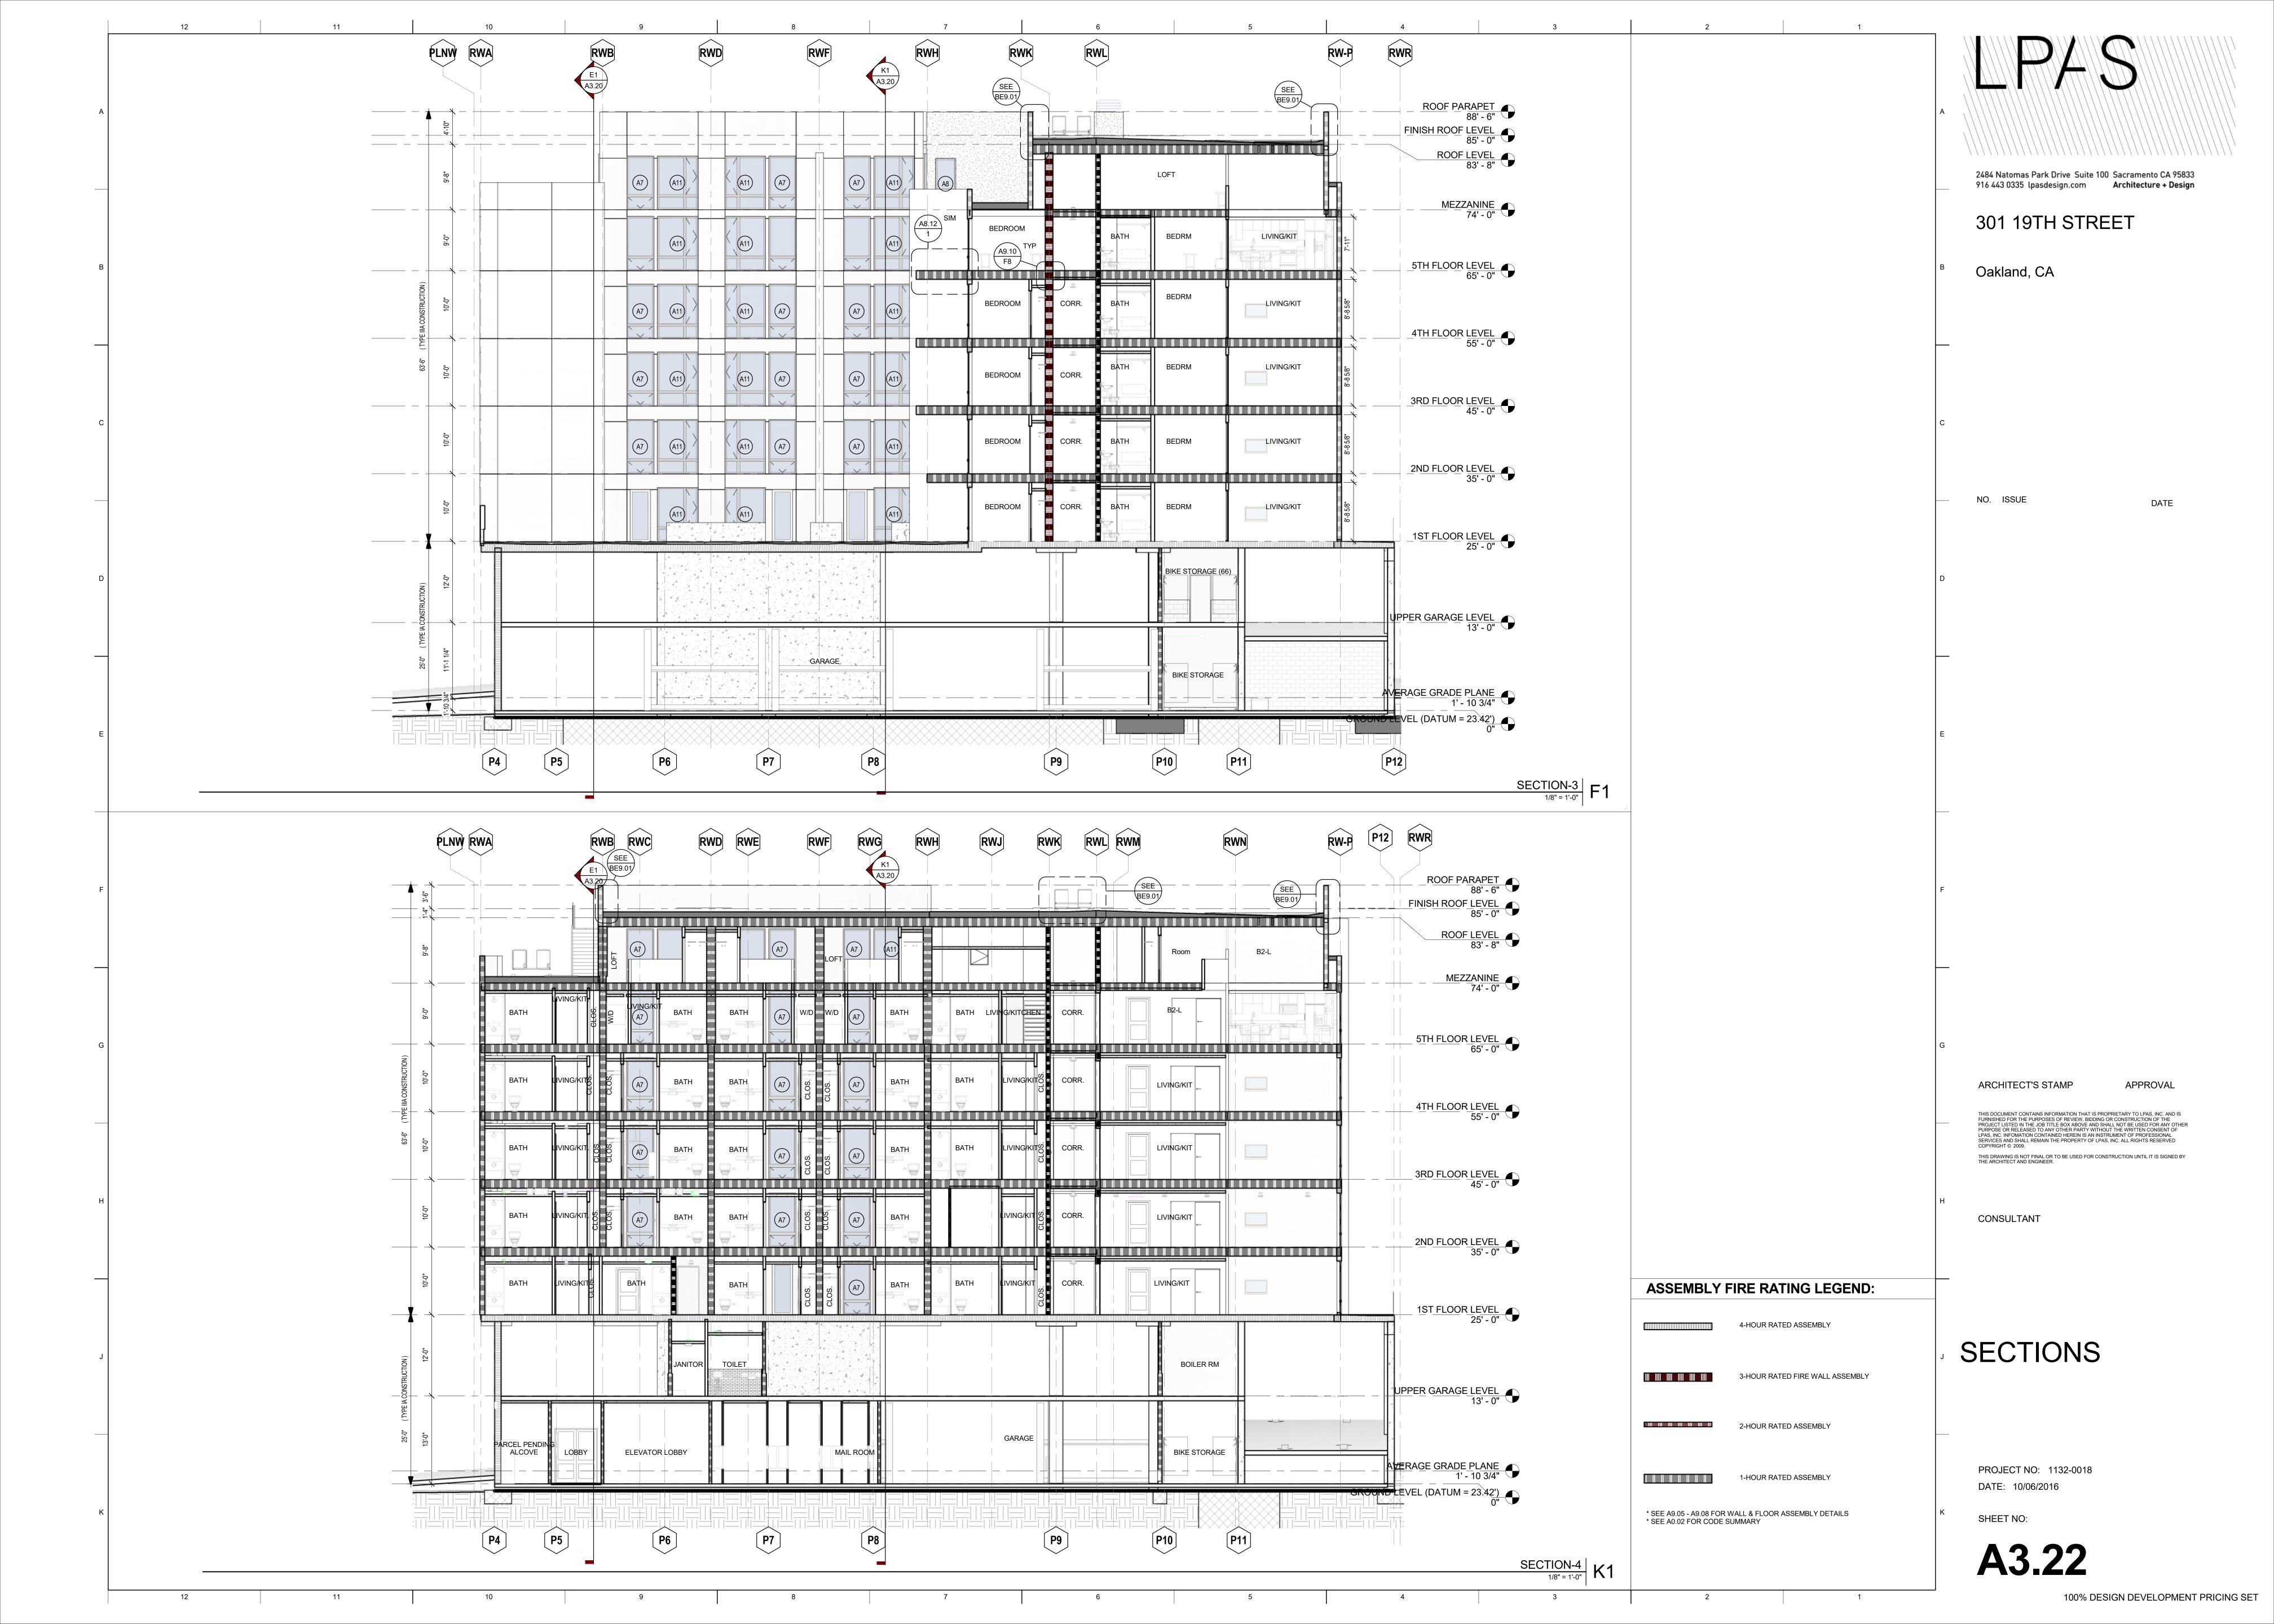

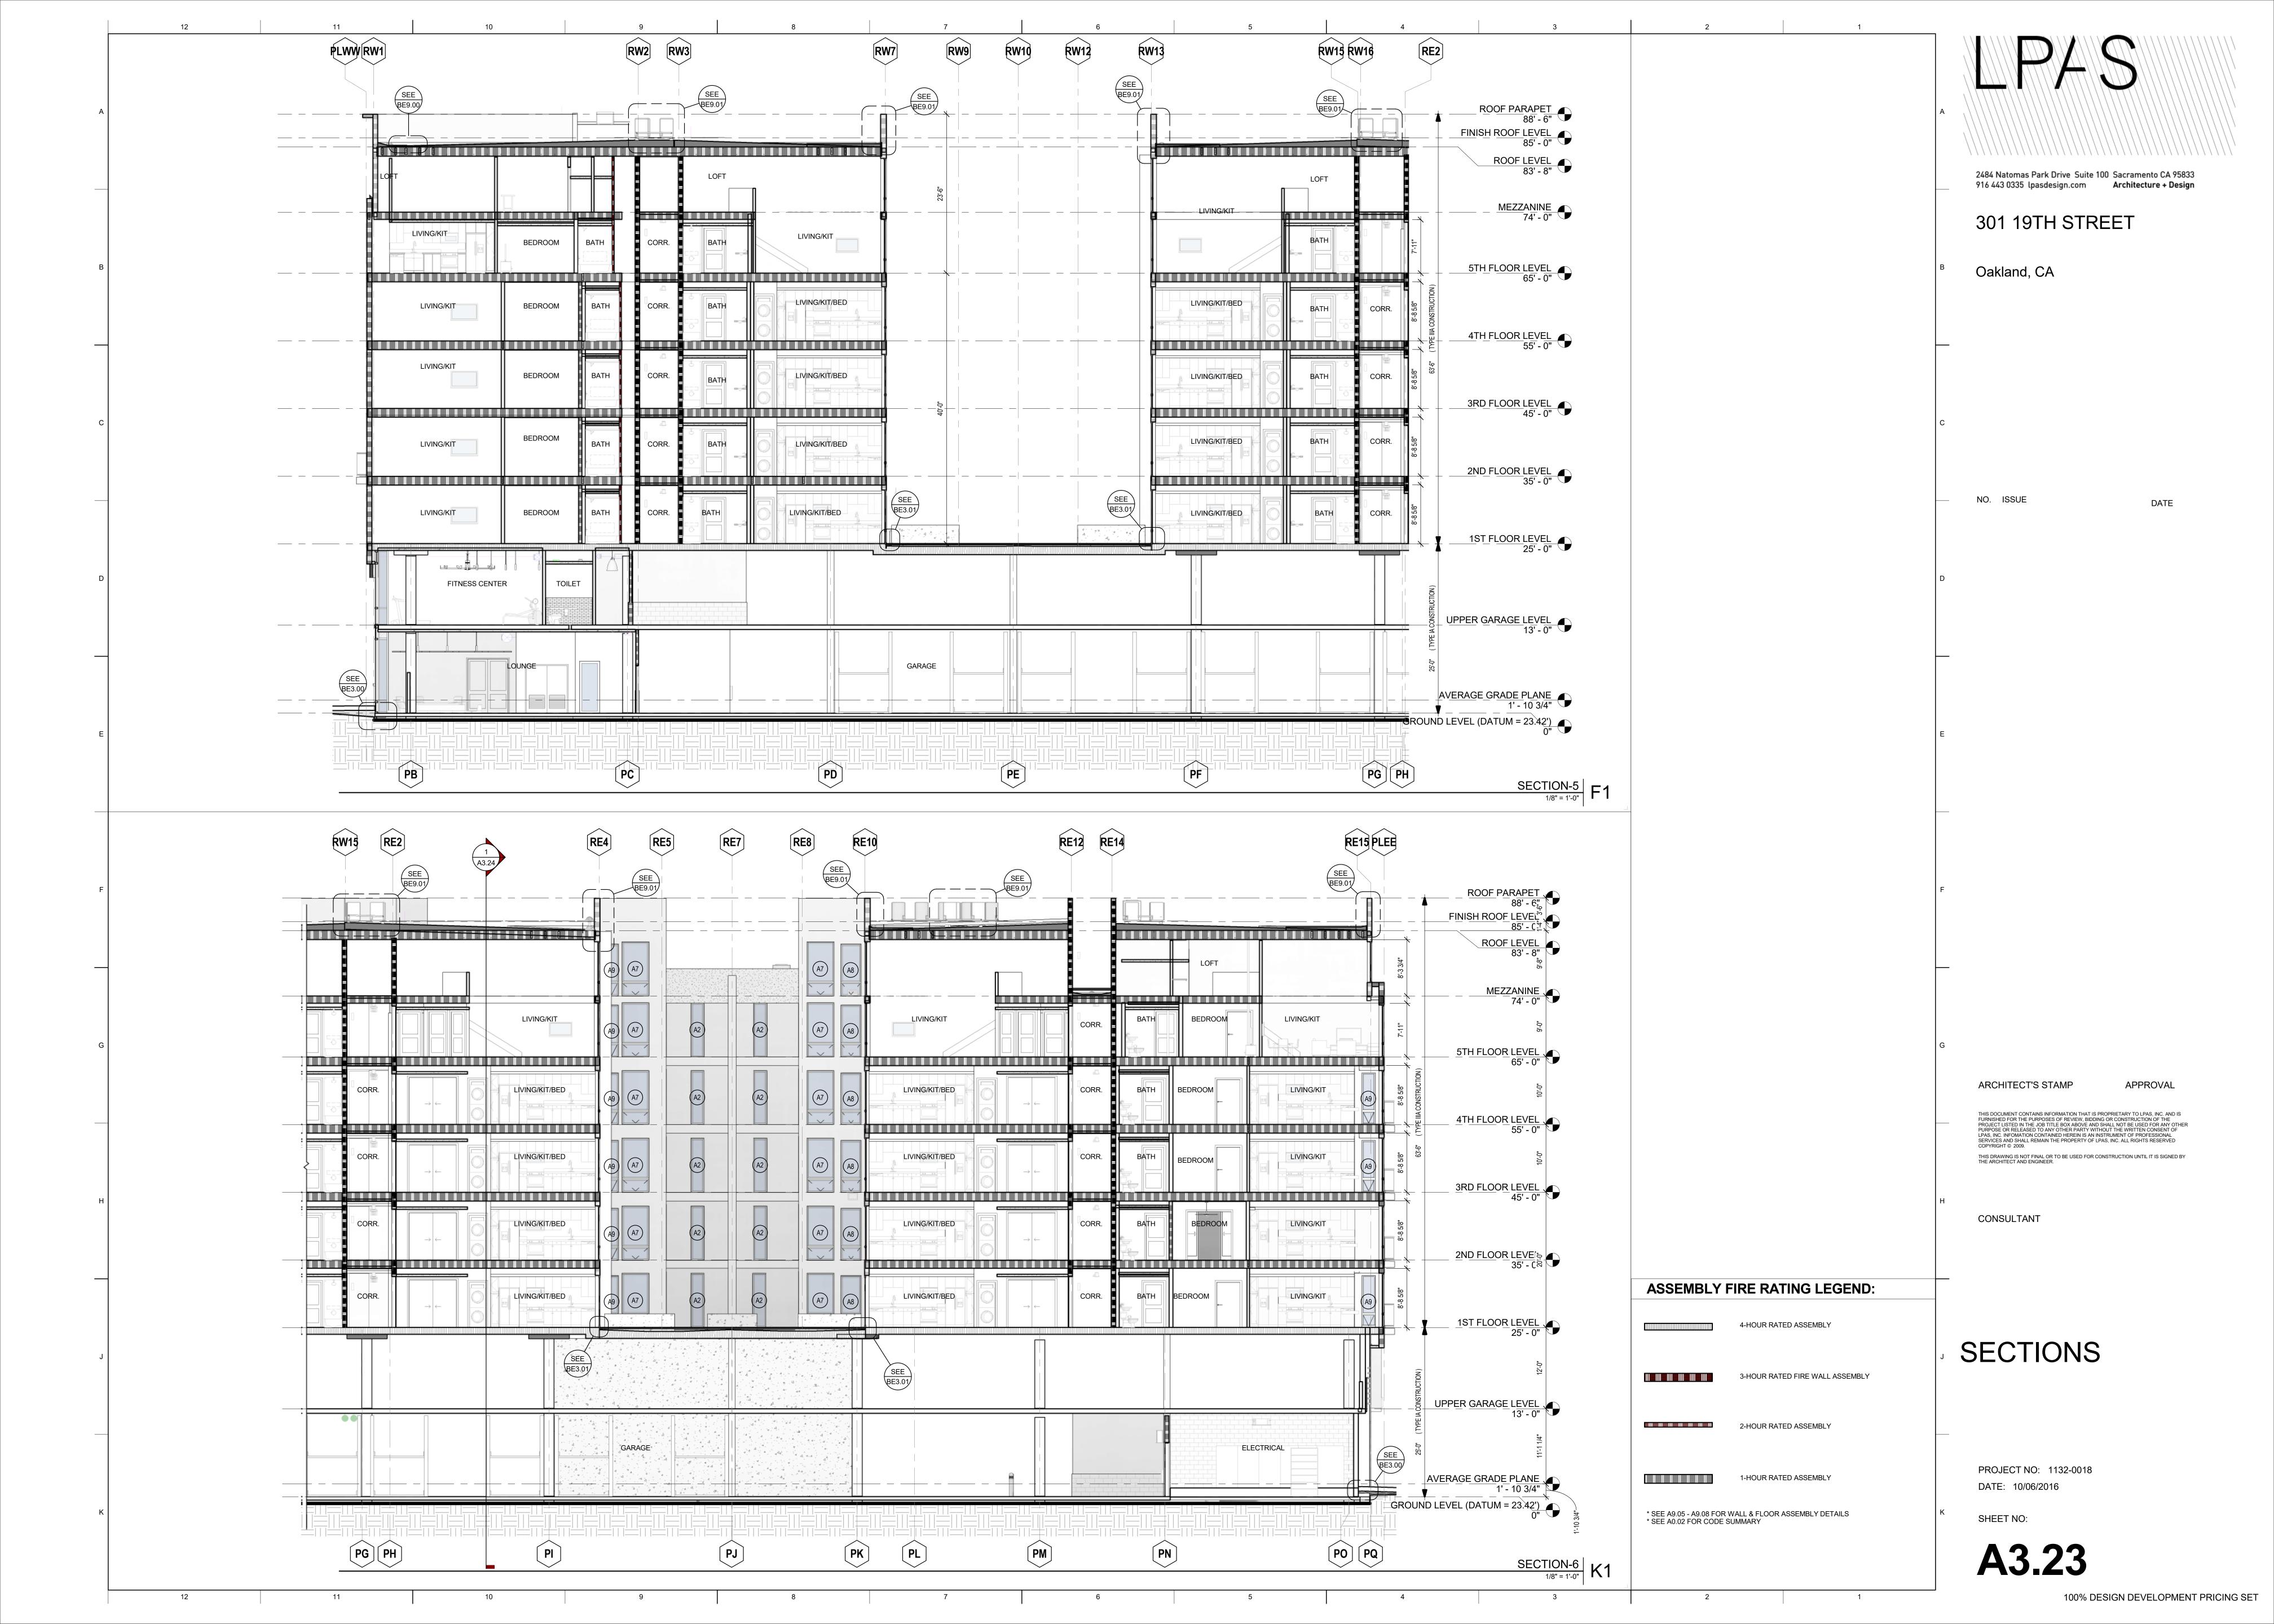

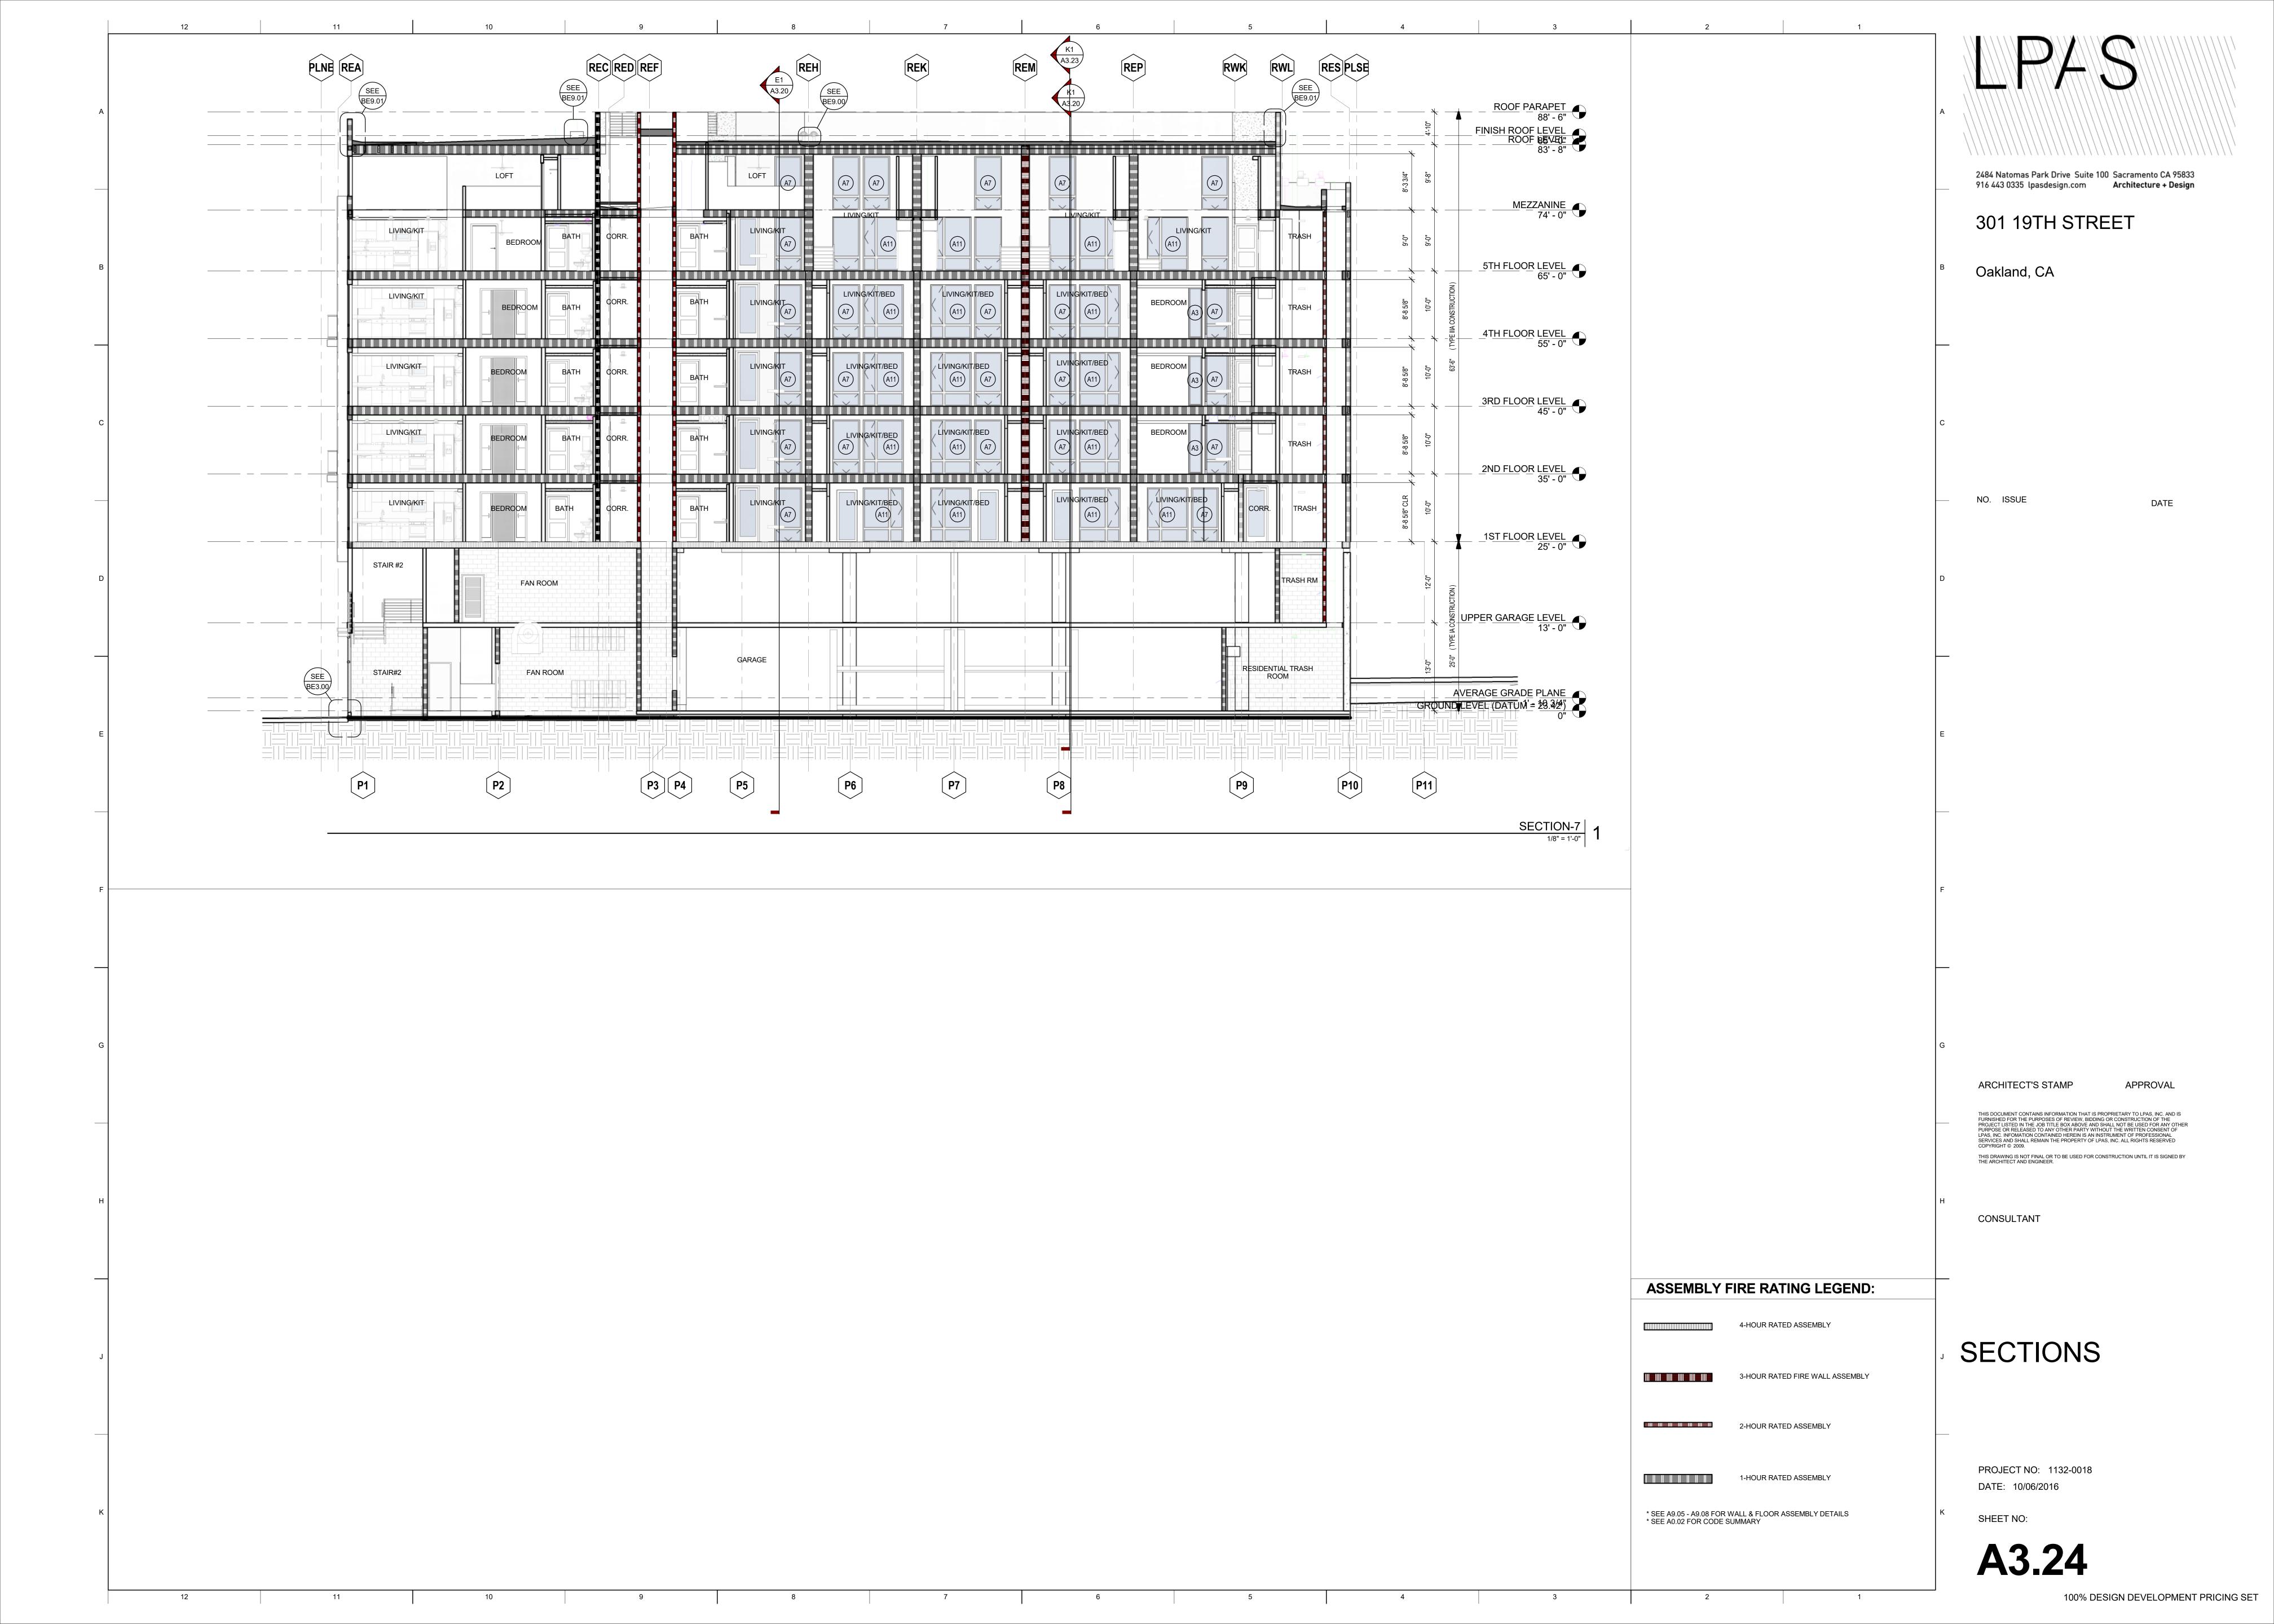

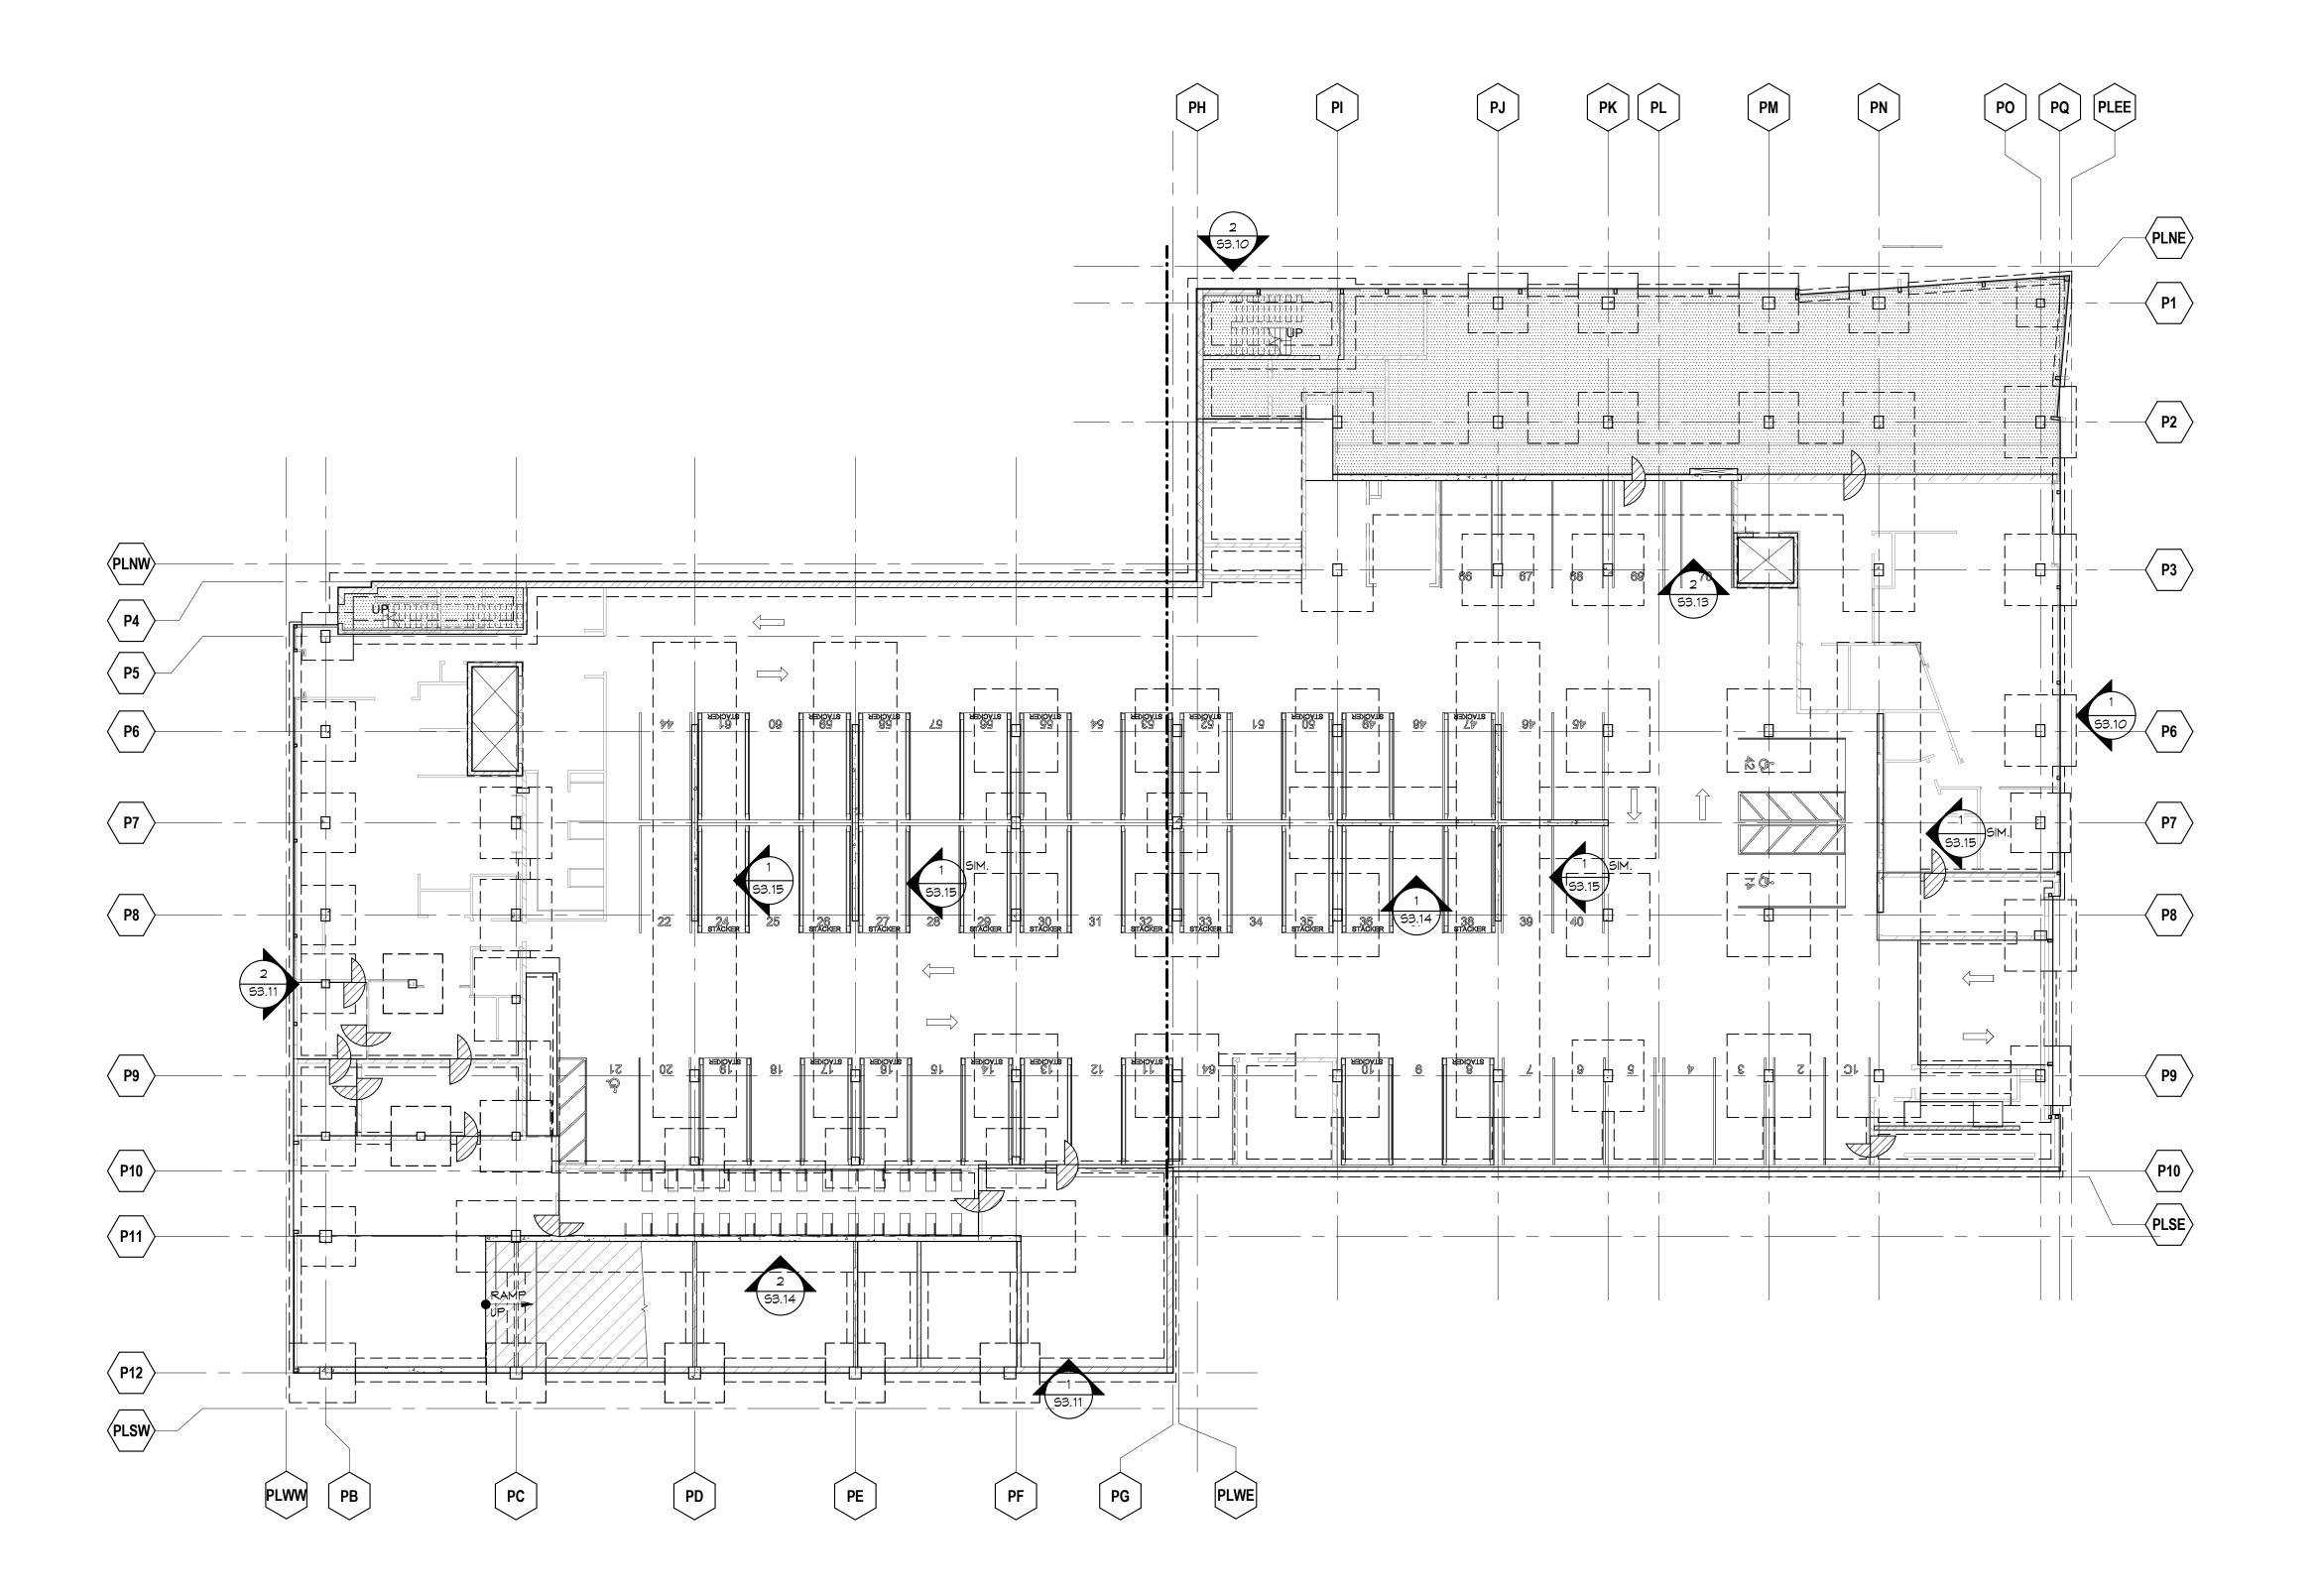

GROUND LEVEL OVERALL FOUNDATION PLAN

**FOUNDATION PLAN NOTES** 

1. SEE GENERAL NOTES AND DETAILS ON SHEETS S1.0 AND S1.1

2. SEE ARCHITECTURAL PLAN FOR ACTURAL FINISH FLOOR AND PAD ELEVATIONS.

3. EXCAVATIONS SHALL BE MADE AS NEAR AS POSSIBLE TO THE LINES REQUIRED BY THE FOOTING. NO MATERIAL IS TO BE OVER EXCAVATED UNNECESSARILY.

4. VERIFY LOCATION OF UNDERGROUND UTILITIES BEFORE EXCAVATION. NOTIFY ARCHITECT PRIOR TO EXCAVATION IN THE EVENT SUCH UTILITIES ARE ENCOUNTERED.

 FOR DRAINAGE DETAILS, SUMPS, PITS, DAMPROOFING, TRENCHES, CURBS, EXTERIOR WALKS, UTILITIES, EQUIPMENT DETAILS, STEPS, DIMENSIONS NOT SHOWN, ETC., SEE DRAWINGS OTHER THAN STRUCTURAL.

6. SETBACK CONDITIONS SHALL BE VERIFIED IN THE FIELD PRIOR TO TRENCHING AND FORMING FOUNDATION. THE FOUNDATION SUBCONTRACTOR SHALL COORDINATE WITH THE GENERAL CONTRACTOR, SURVEYOR, AND THE ARCHITECT.

GEOTECHNICAL ENGINEER SHALL BE RETAINED TO PROVIDE OBSERVATION AND JTESTING SERVICES DURING THE GRADING AND FOUNDATION PHASE OF CONSTRUCTION, AND THAT INSPECTION AND TESTING REPORTS SHALL BE SUBMITTED TO THE BUILDING

2484 Natomas Park Drive Suite 100 Sacramento CA 95833 916 443 0335 lpasdesign.com Architecture + Design

**301 19TH STREET** 

301 19th Street, Oakland, CA

NO. ISSUE

ARCHITECT'S STAMP

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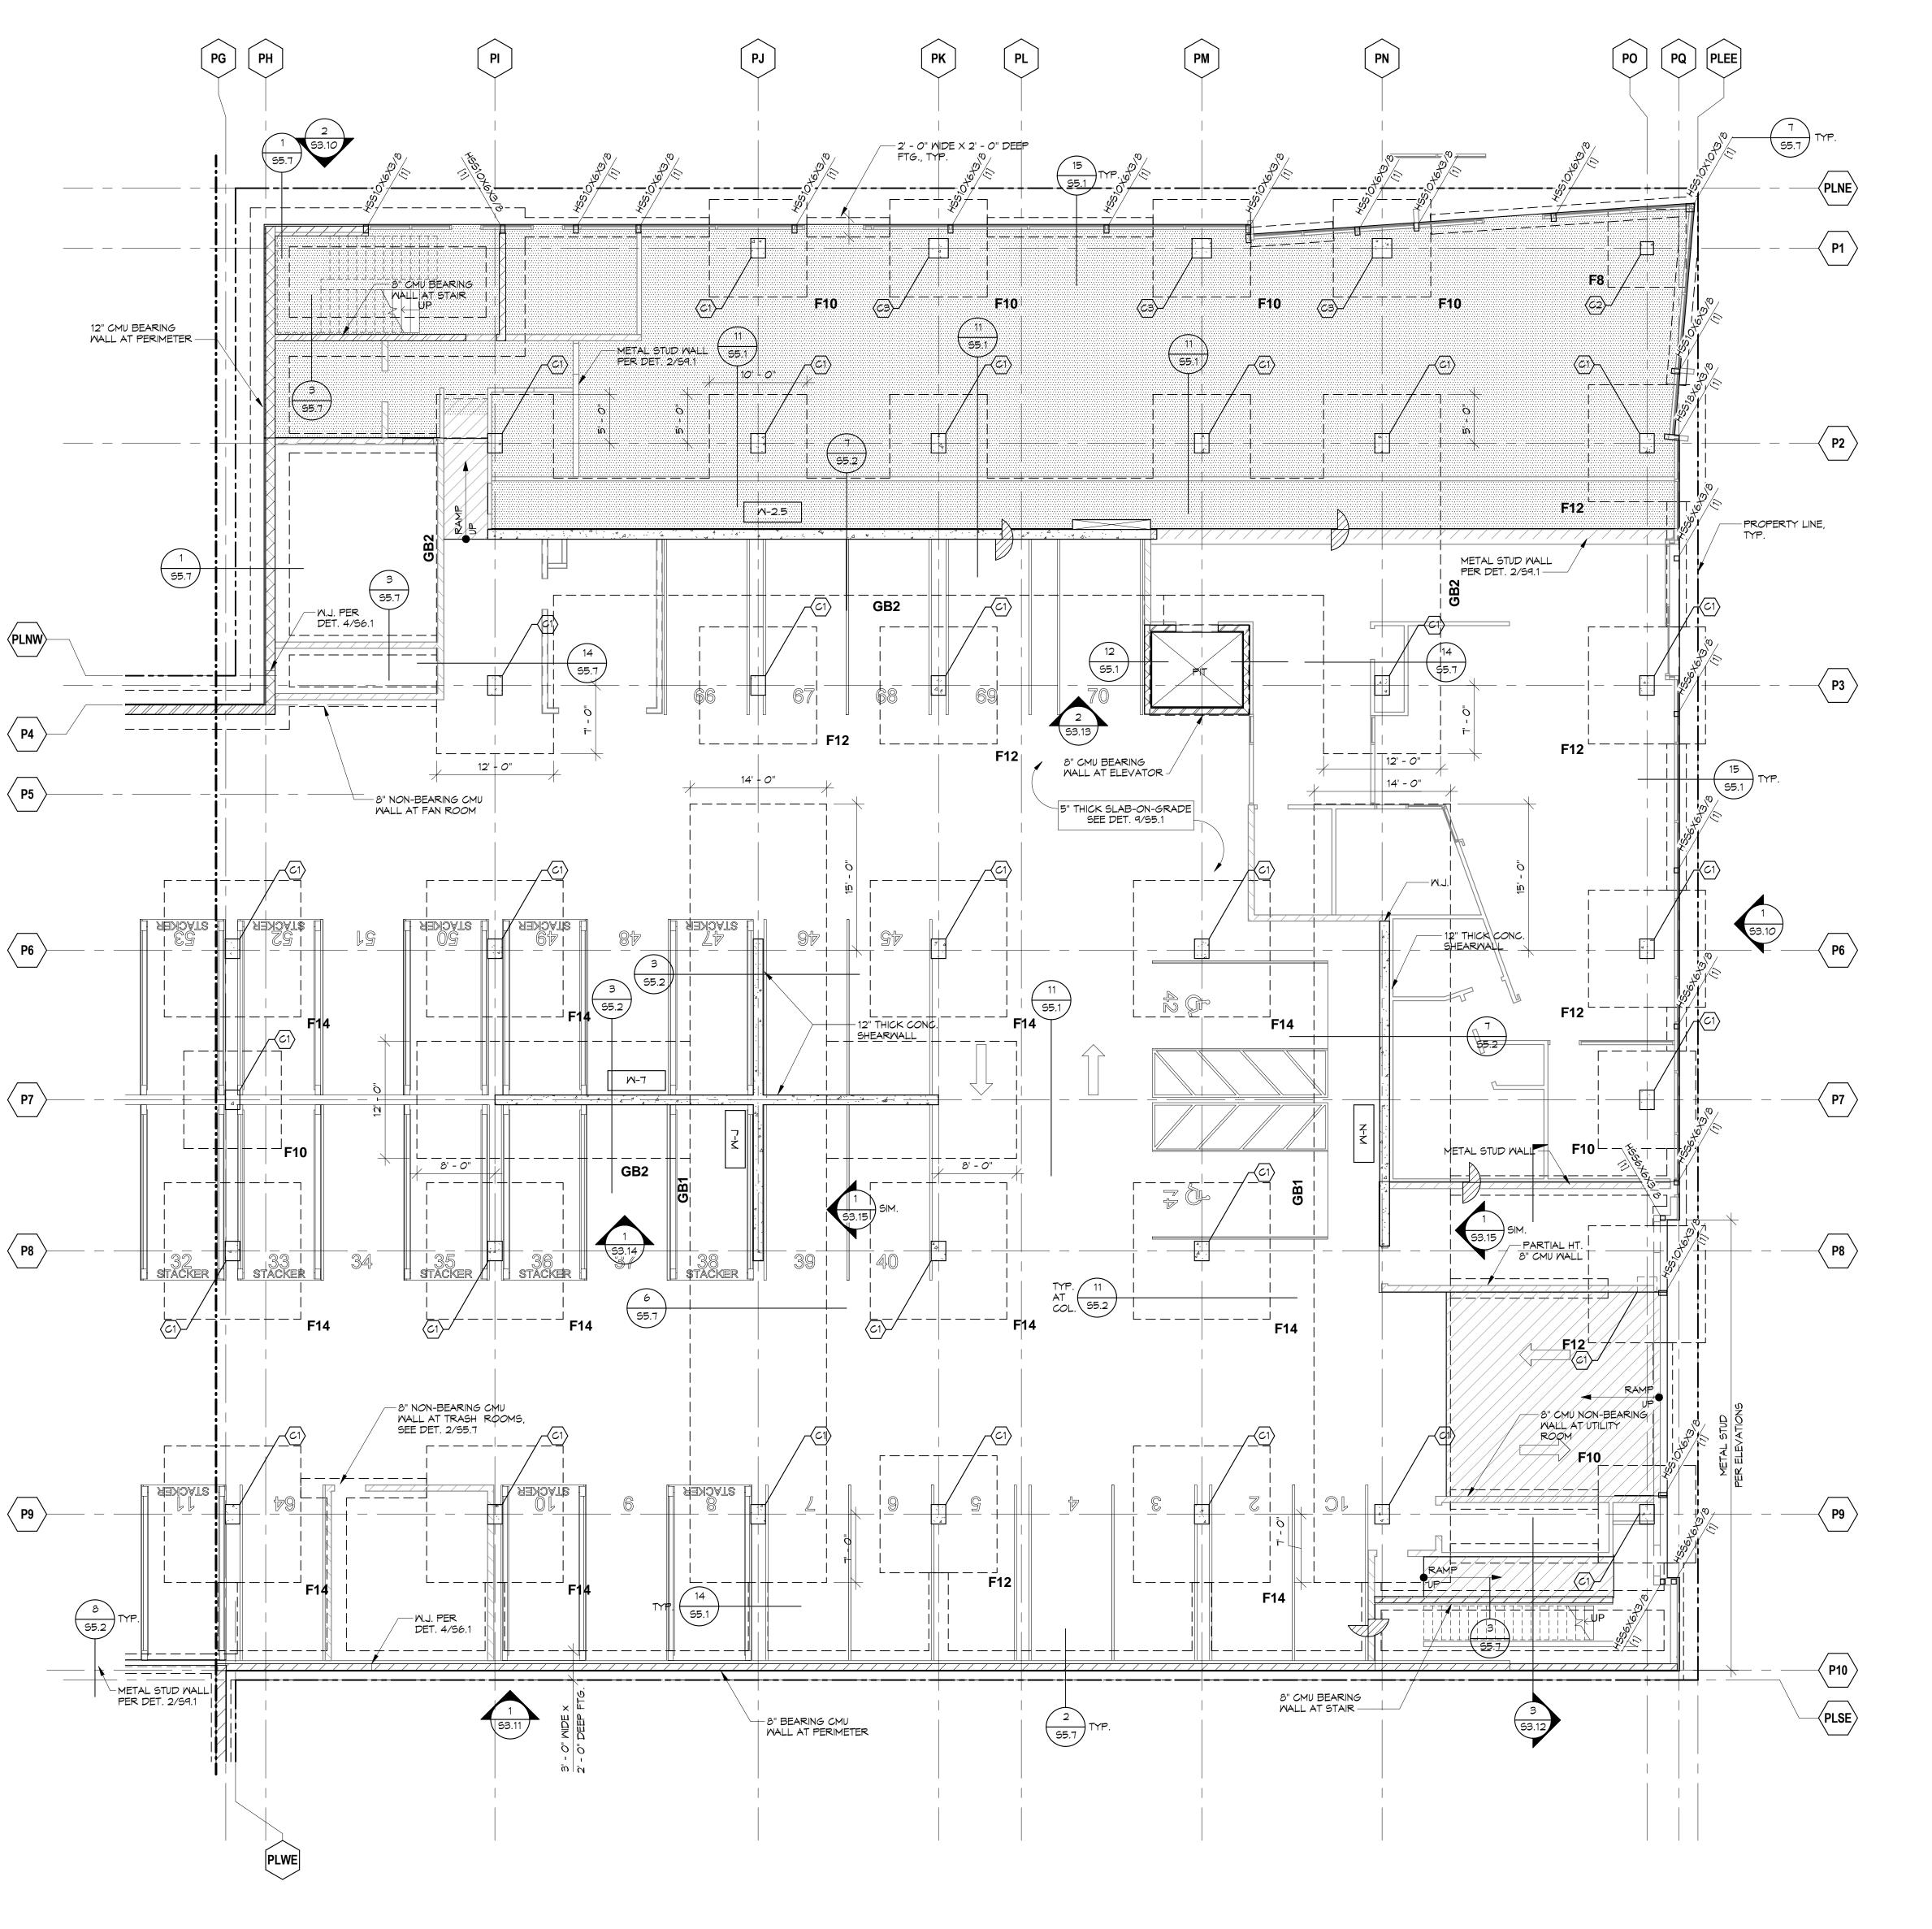


**GROUND FLOOR** FOUNDATION PLAN -**OVERALL** 

PROJECT NO: 1132-0018 DATE: 10/06/2016

SHEET NO:

100% DESIGN DEVELOPMENT PRICING SET



#### FOUNDATION PLAN NOTES

- 1. SEE GENERAL NOTES AND DETAILS ON SHEETS S1.0 AND S1.1
- SEE ARCHITECTURAL PLAN FOR ACTURAL FINISH FLOOR AND PAD ELEVATIONS.
- 3. EXCAVATIONS SHALL BE MADE AS NEAR AS POSSIBLE TO THE LINES REQUIRED BY THE FOOTING. NO MATERIAL IS TO BE OVER EXCAVATED UNNECESSARILY.
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CONTRACTOR, SURVEYOR, AND THE ARCHITECT.

- FOR DRAINAGE DETAILS, SUMPS, PITS, DAMPROOFING, TRENCHES, CURBS, EXTERIOR WALKS, UTILITIES, EQUIPMENT DETAILS, STEPS, DIMENSIONS NOT SHOWN, ETC., SEE DRAWINGS OTHER THAN STRUCTURAL.
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GROUND FLOOR FOUNDATION PLAN -EAST

PROJECT NO: 1132-0018 DATE: 10/06/2016


SHEET NO:

S2.01 E

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GROUND LEVEL FOUNDATION PLAN - EAST

1/8" = 1'-0"

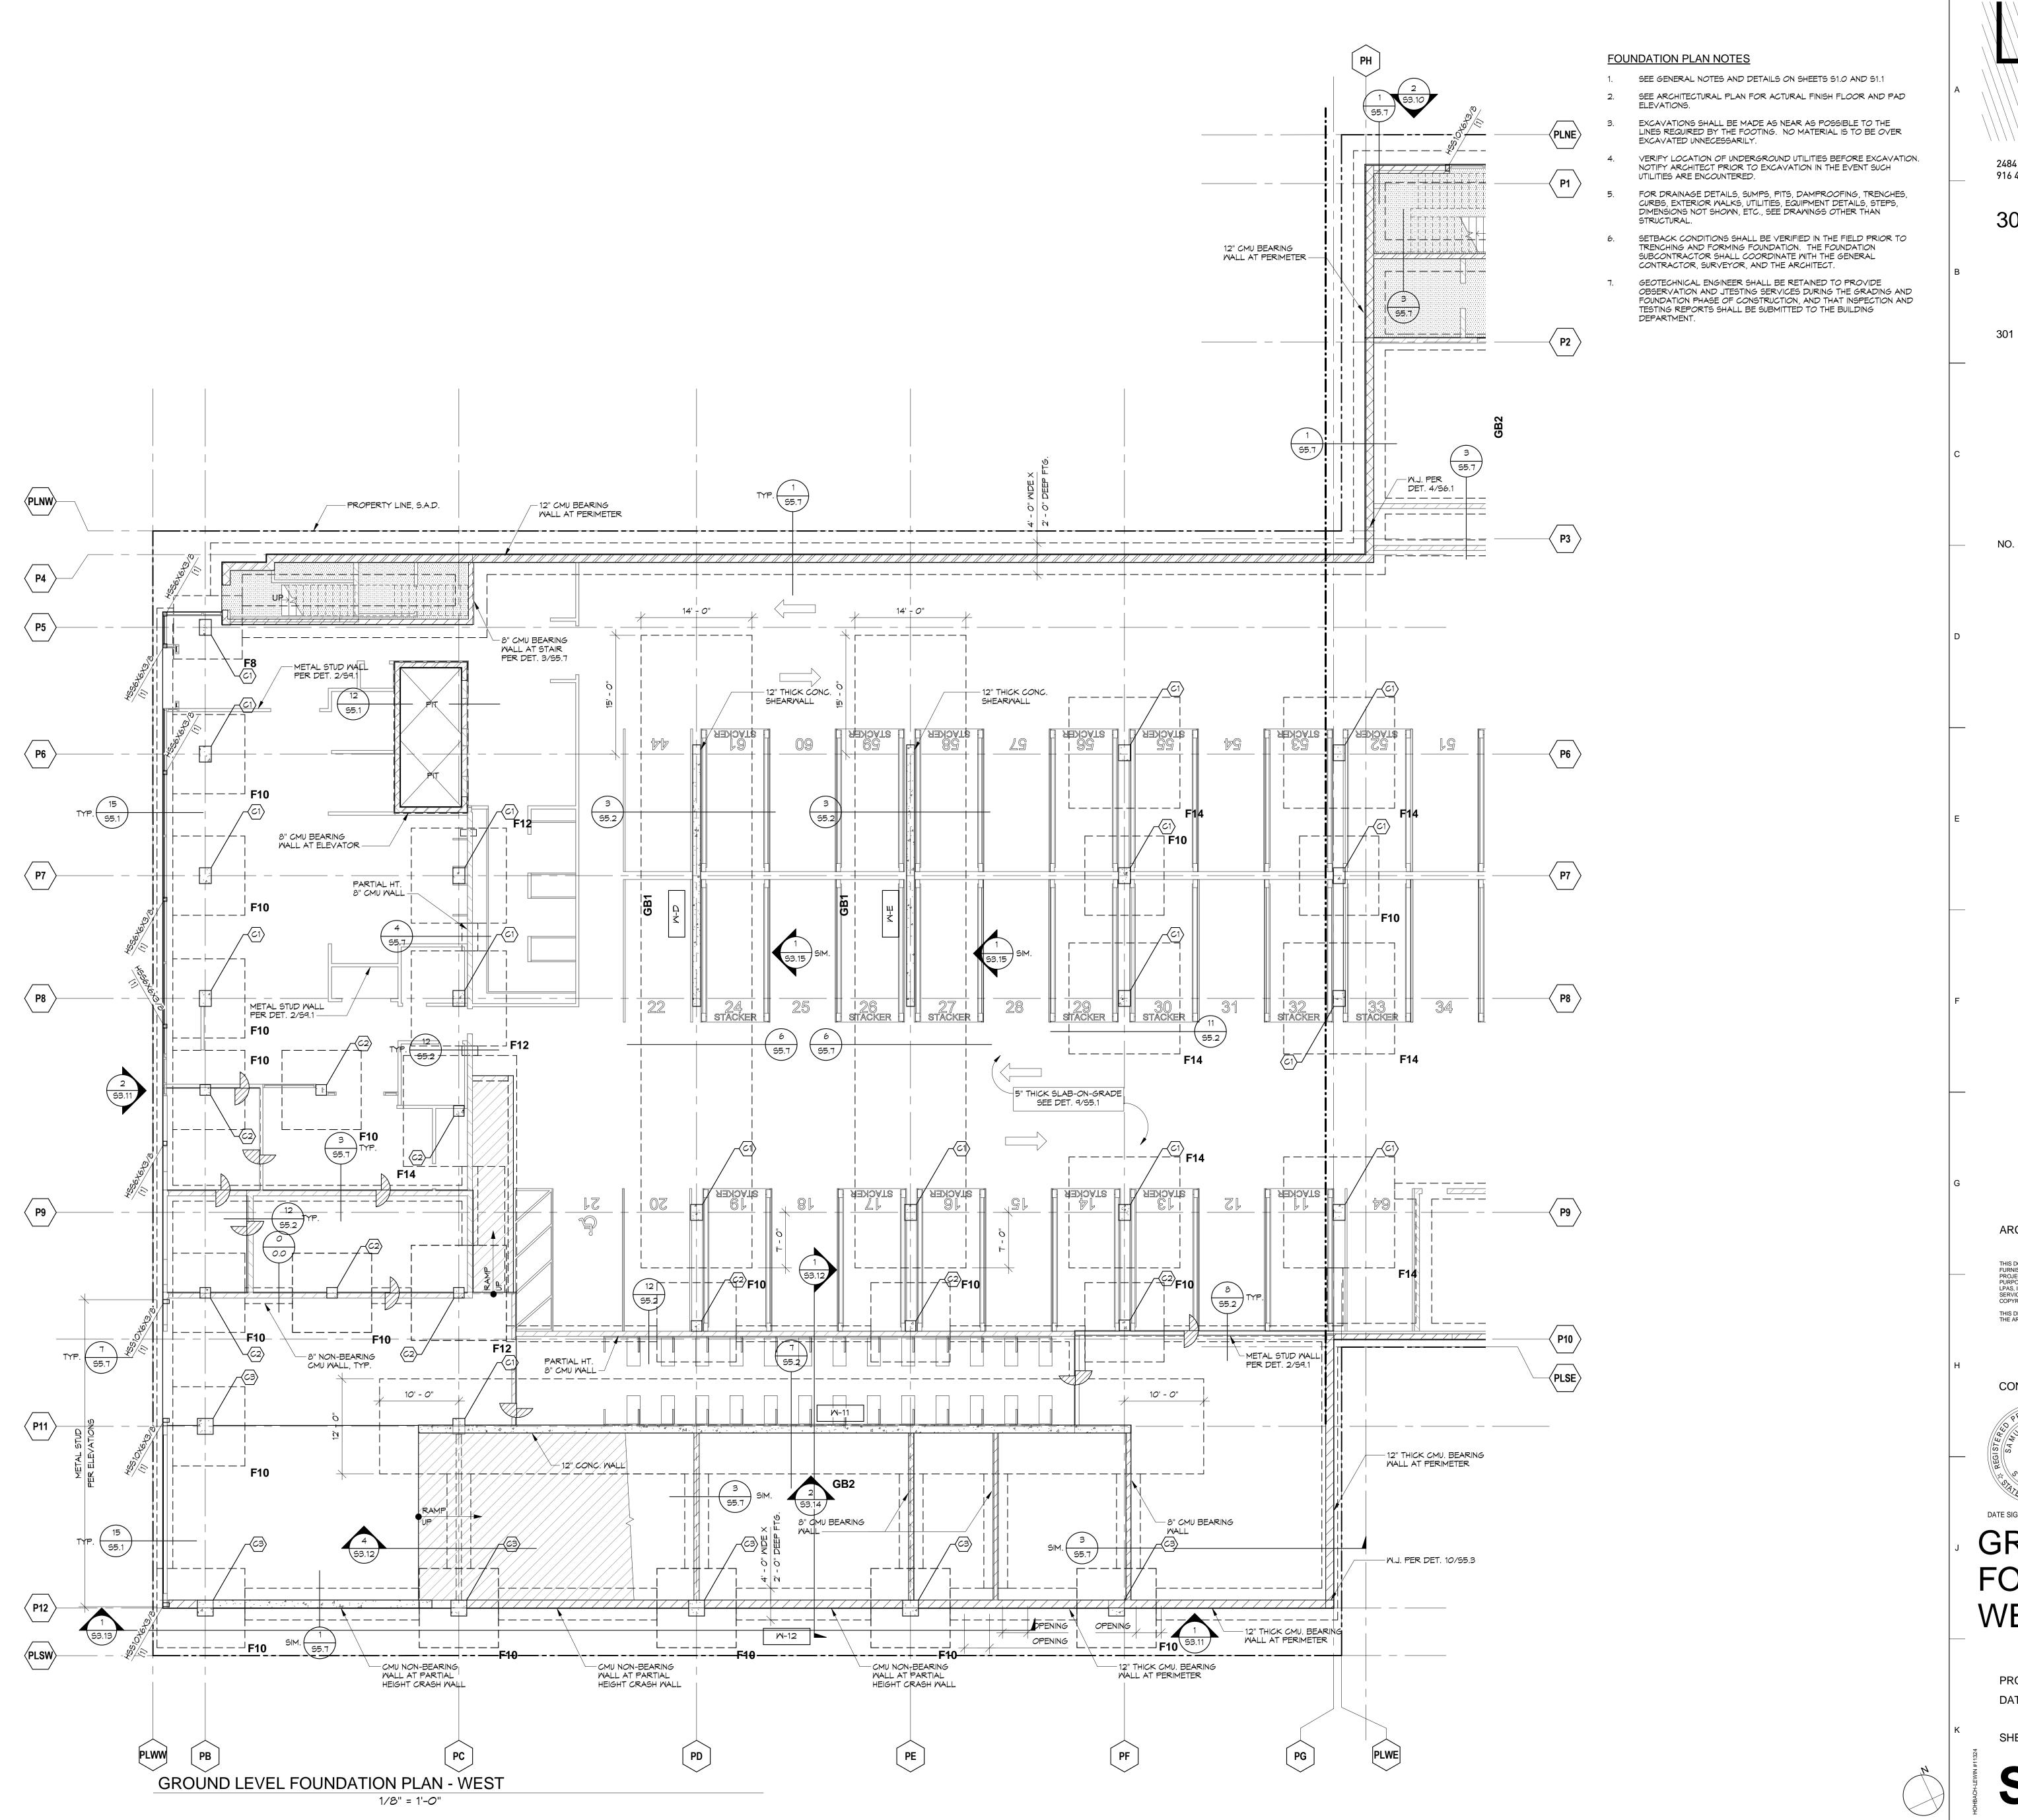

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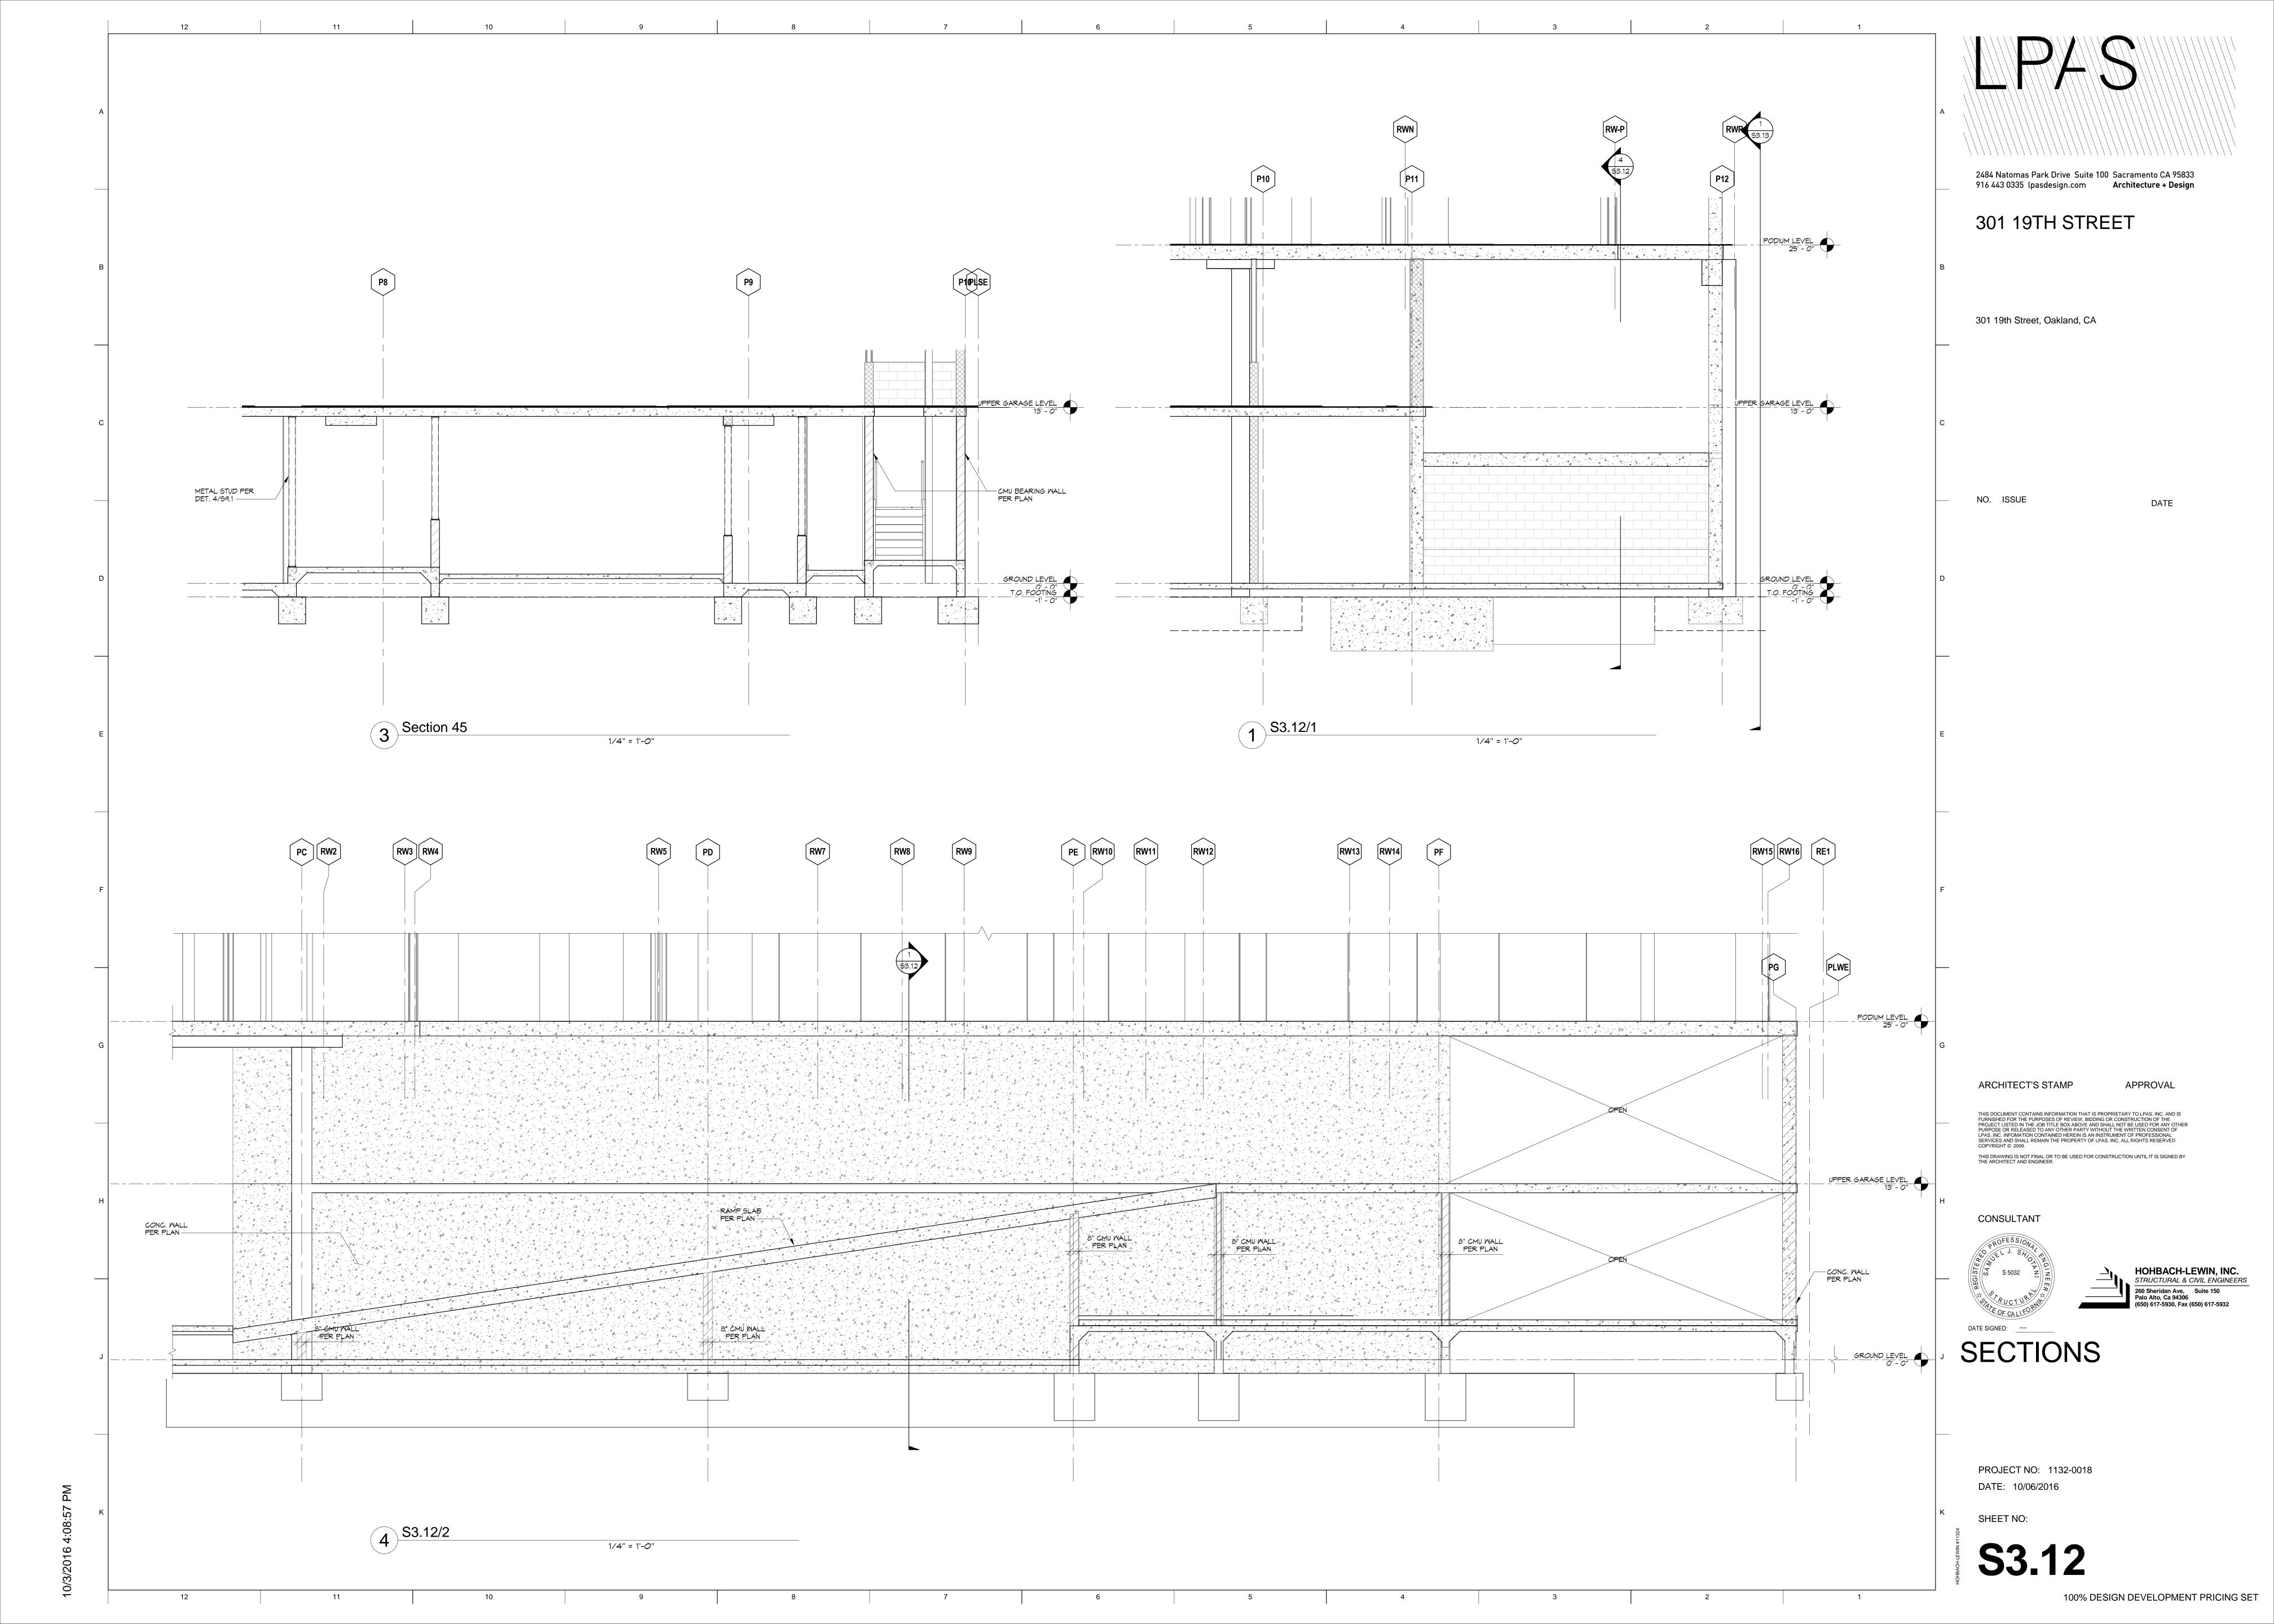



GROUND FLOOR FOUNDATION PLAN -WEST


PROJECT NO: 1132-0018 DATE: 10/06/2016

SHEET NO:

S2.01 W



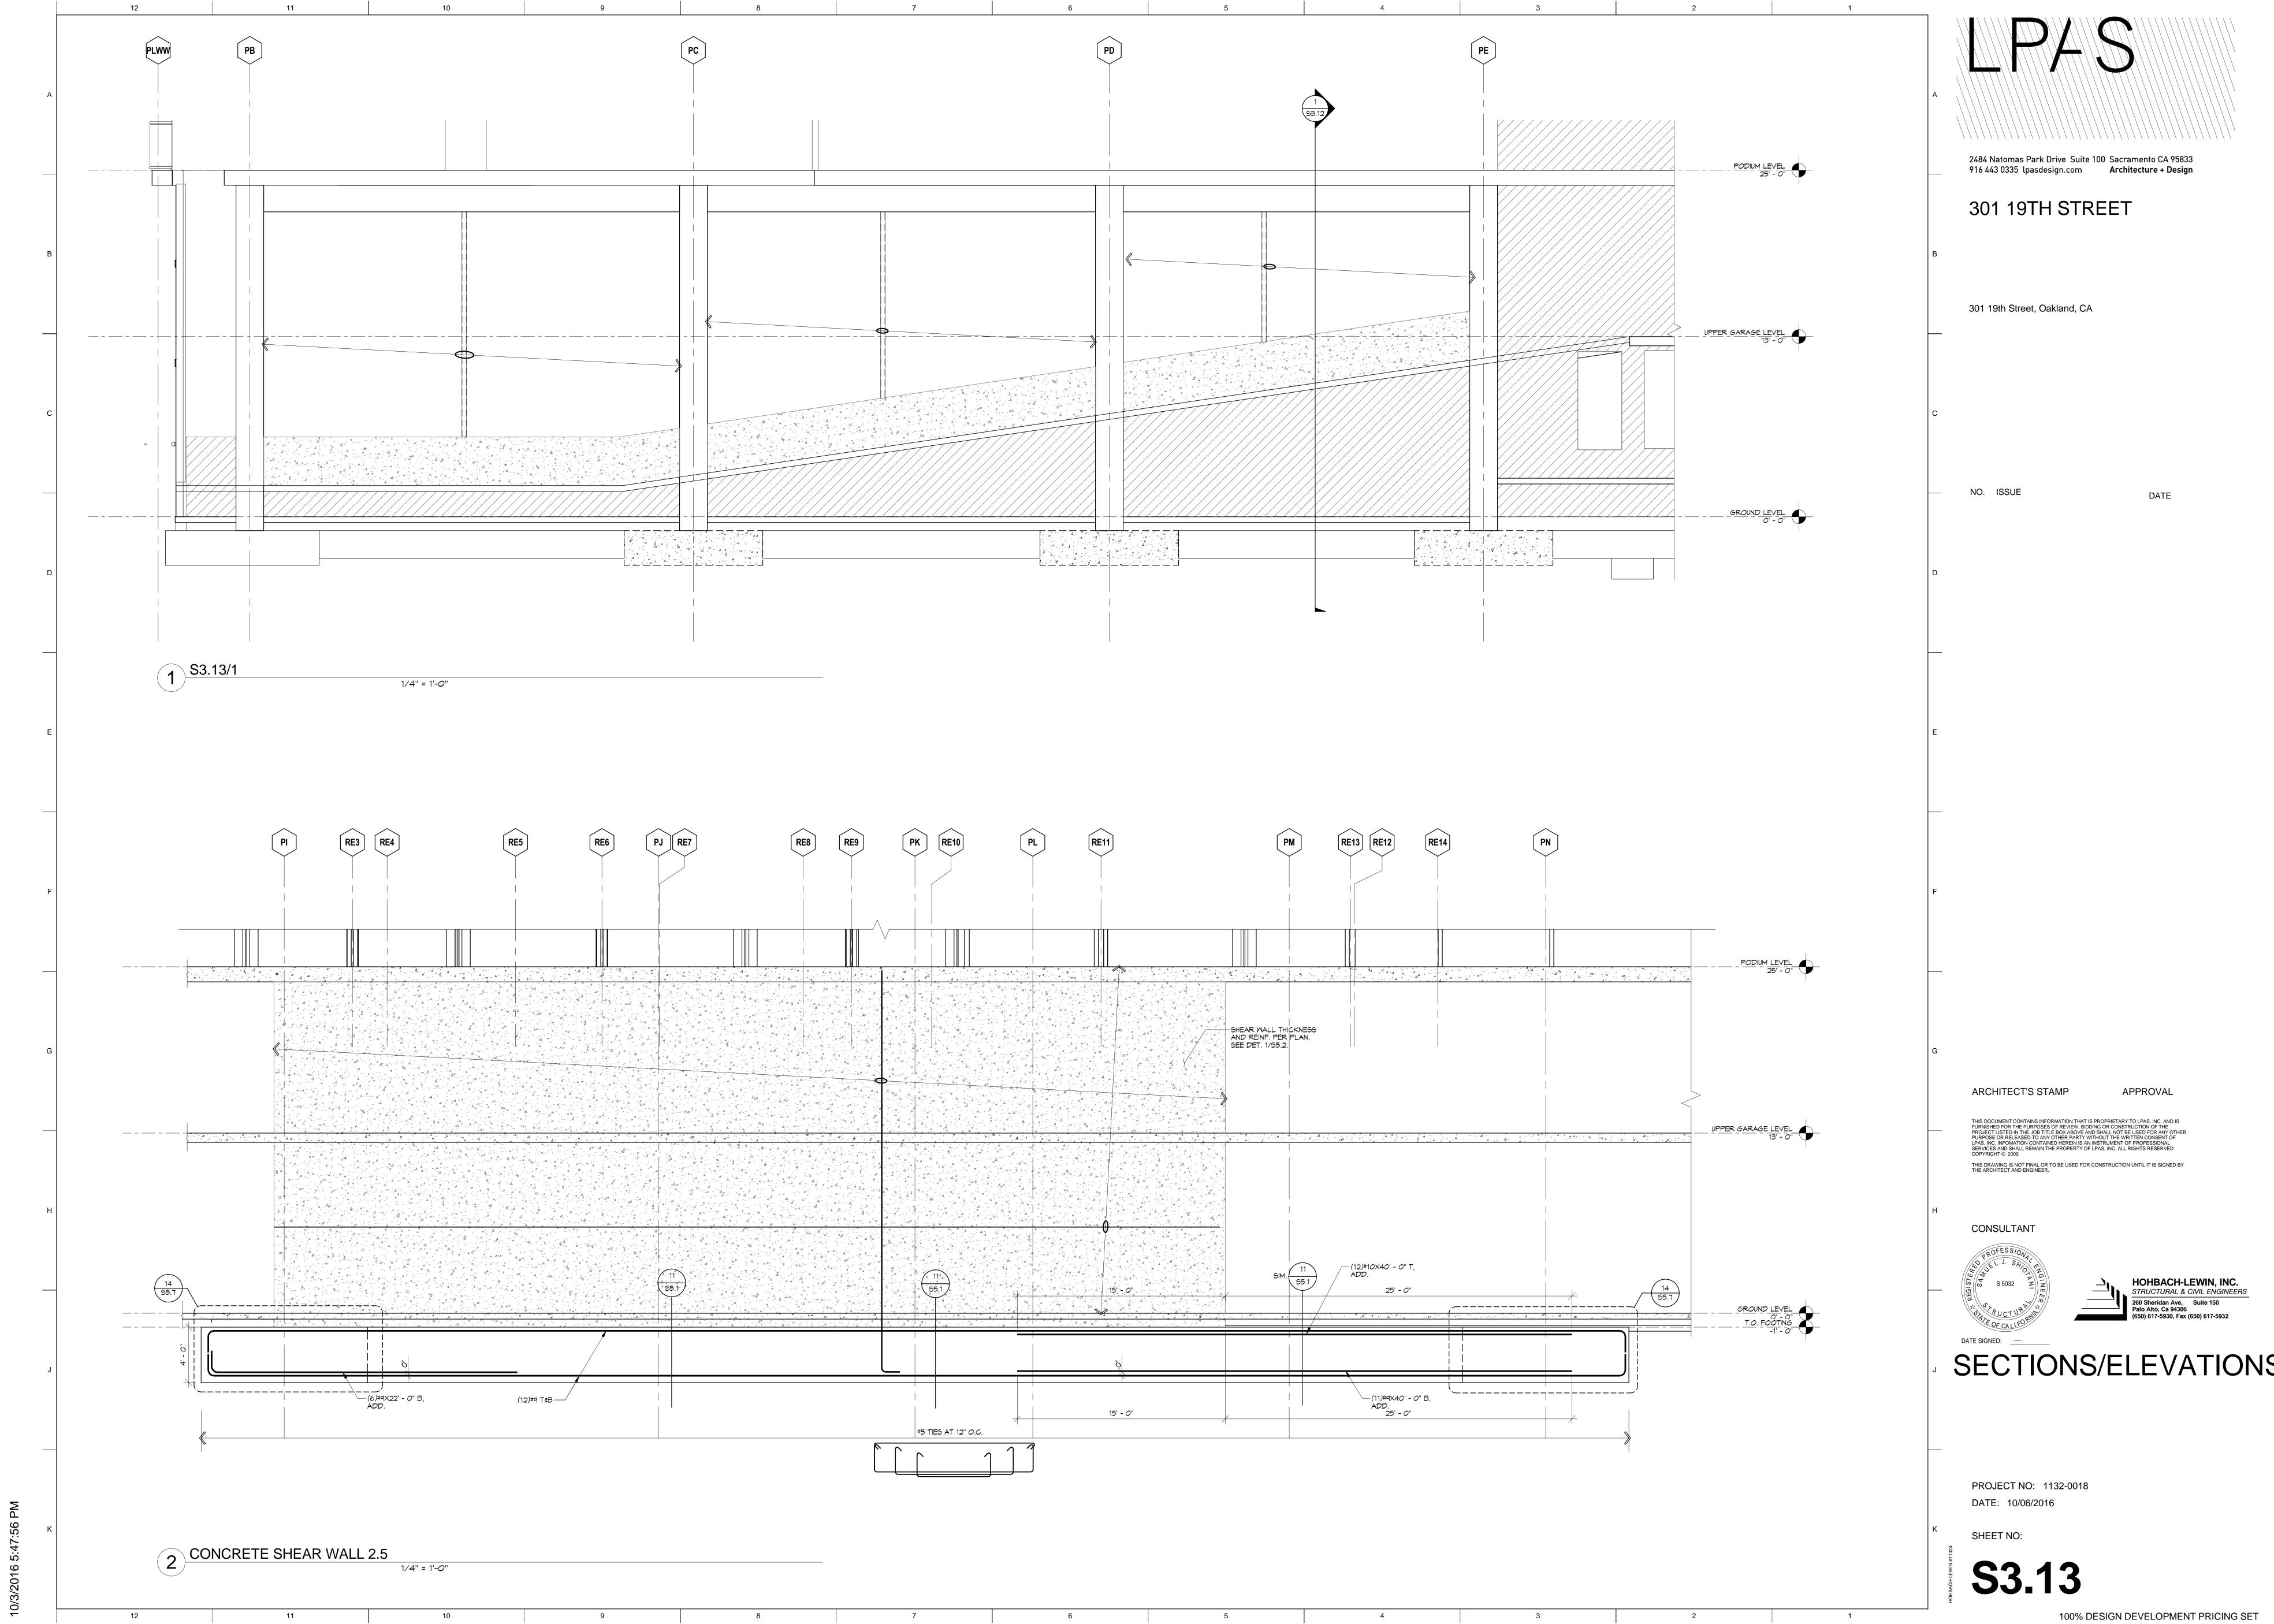

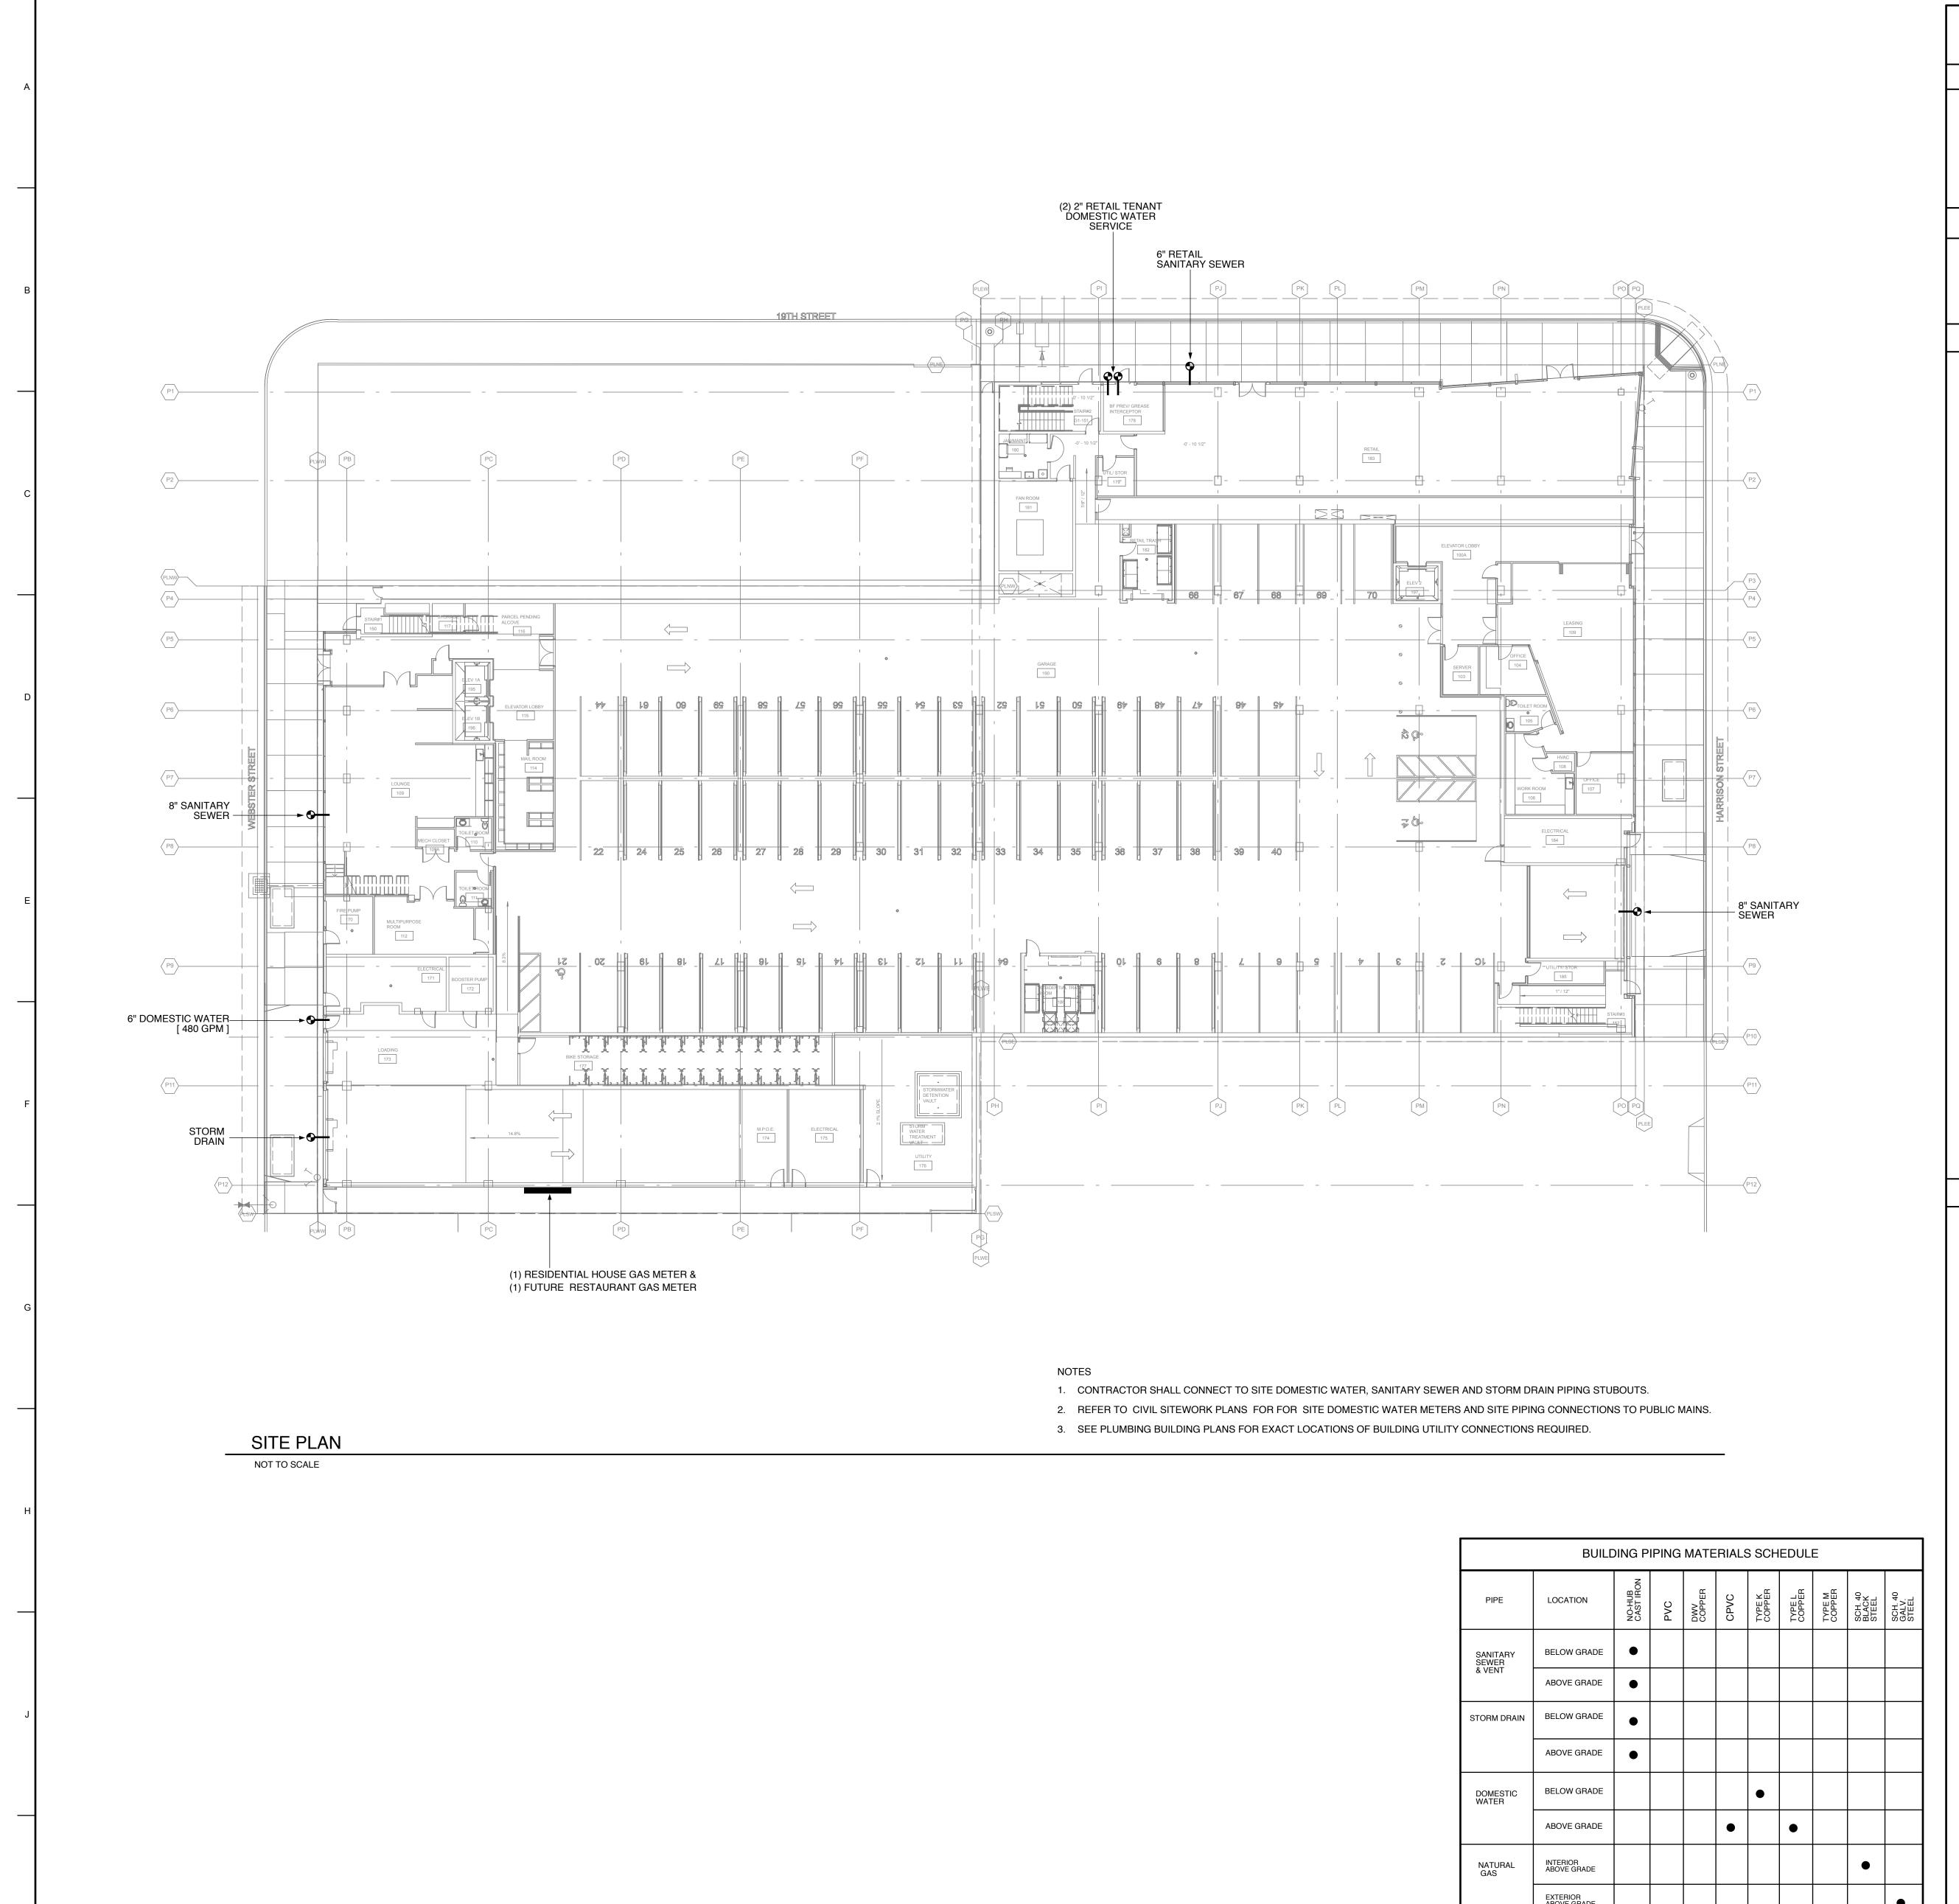

#### BUILDING PLUMBING UTLITY LOADS

#### DOMESTIC WATER

DEMAND FIXTURE UNITS 3,600 WSFU
DEMAND FLOW ESTIMATE 500 GPM

DEMAND PIPE SIZING 6 INCH
PIPE SIZE MAXIMUM VELOCITY 5 FT/SECOND

#### SANITARY SEWER

DEMAND FIXTURE UNITS 2,686 DFU
PIPE SIZING (2)8 INCH

WATER CALCULATIONS

#### WATER SERVICE

AVAILABLE PRESSURE

AVAILABLE STATIC PRESSURE					+ 58 P
LOSS THROUGH METER	6"	SIZE @	500	GPM	5_ P
LOSS THROUGH BACKFLOW DEVICE	6"	SIZE @	500	GPM	<u>-10</u> P

#### NOTE: INADEQUATE PRESSURE AVAILABLE - PRESSURE BOOSTER PUMP REQUIRED

+ 43 PSI

#### BUILDING WATER SUPPLY INFORMATION

MAXIMUM CW DEMAND	<u>500</u> GPM
PRESSURE BOOSTER PUMP OUTLET PRESSURE	75_ PSI
PRESSURE AT REMOTE FIXTURE	<u>- 20</u> PSI
STATIC LOSS BUILDING HEIGHT 74 FT. X 0.43 =	32 PSI
AVAILABLE PRESSURE FOR FRICTION LOSS	23_ PSI

## PIPING SUPPLY INFORMATION AVAILABLE PRESSURE FOR FRICTION LOSS

AVAILABLE PRESSURE FOR FRICTION LOSS	23	PSI
TOTAL DEVELOPED LENGTH TDL	600	FEET
FRICTION LOSS RATE 23 AVAILABLE PSI / 600 TDL X 100 =	3.8	PSI /100 FT

	CPVC PIPE SIZING SUMMARY				
	PIPE SIZE	WATER WSFU	WATER GPM	VELOCITY	MAXIMUM PRESSURE DROP
	1/2"	1	2	3.4 FPS	3.9 PSI / 100 FT
	3/4"	4	4	3.2 FPS	
=	1"	12	9	4.3 FPS	
SDR	1-1/4"	20	15	4.8 FPS	
S	1-1/2"	30	20	4.6 FPS	
	2"	66	35	4.7 FPS	
	2-1/2"	175	60	4.6 FPS	
	3"	380	100	4.9 FPS	
80	4"	778	175	4.9 FPS	
SCH	5"	1335	250	4.5 FPS	
	6"	3620	500	6.0 FPS	
	8"	8300	1000	7.0 FPS	$\downarrow$

## GAS METER LOADS

RESIDENTIAL HOUSE GAS METER LOADS					
ITEM	Qty	MBH	Totals		
WATER HEATER	2	1,700	3,400		
POOL/SPA HEATERS	0	0	0		
HVAC	0	0	0		
RESIDENTIAL RANGES	224	65	14,560		
AMENITY RANGES	0	0	0		
LANDSCAPE BBQS	4	75	300		
OUTDOOR FIREPLACES	4	80	320		
INDOOR FIREPLACES	0	0	0		
INDOORT INC. LAOLO					

SERVICE PRESSURE REQUEST: 2 PSI

CONDENSATE

(1) FUTURE RETAIL GAS METER			
RETAIL GAS METER LOAD ESTIMATE			
( 1 ) FUTURE RETAIL TENANT GAS METER ALLOWANCE FOR MAXIMUM ONE RETAIL RESTAURANT			
KITCHEN EQUIPMENT & HEATING ALLOWANCE	2,500 MBH		
TOTAL LOAD (MBH):	2,500 MBH		
SERVICE PRESSURE REQUEST: 2 PSI			

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Oakland, CA

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## CONSULTANT

JMC Consulting Engineers, Inc. 612 Kentucky Street Lawrence, KS 66044 jmcinc@me.com 1-888-322-3321


## SITE PLAN

PROJECT NO: 1132-0018 DATE: 10/06/2016

SHEET NO:

P1.03

100% DESIGN DEVELOPMENT PRICING SET

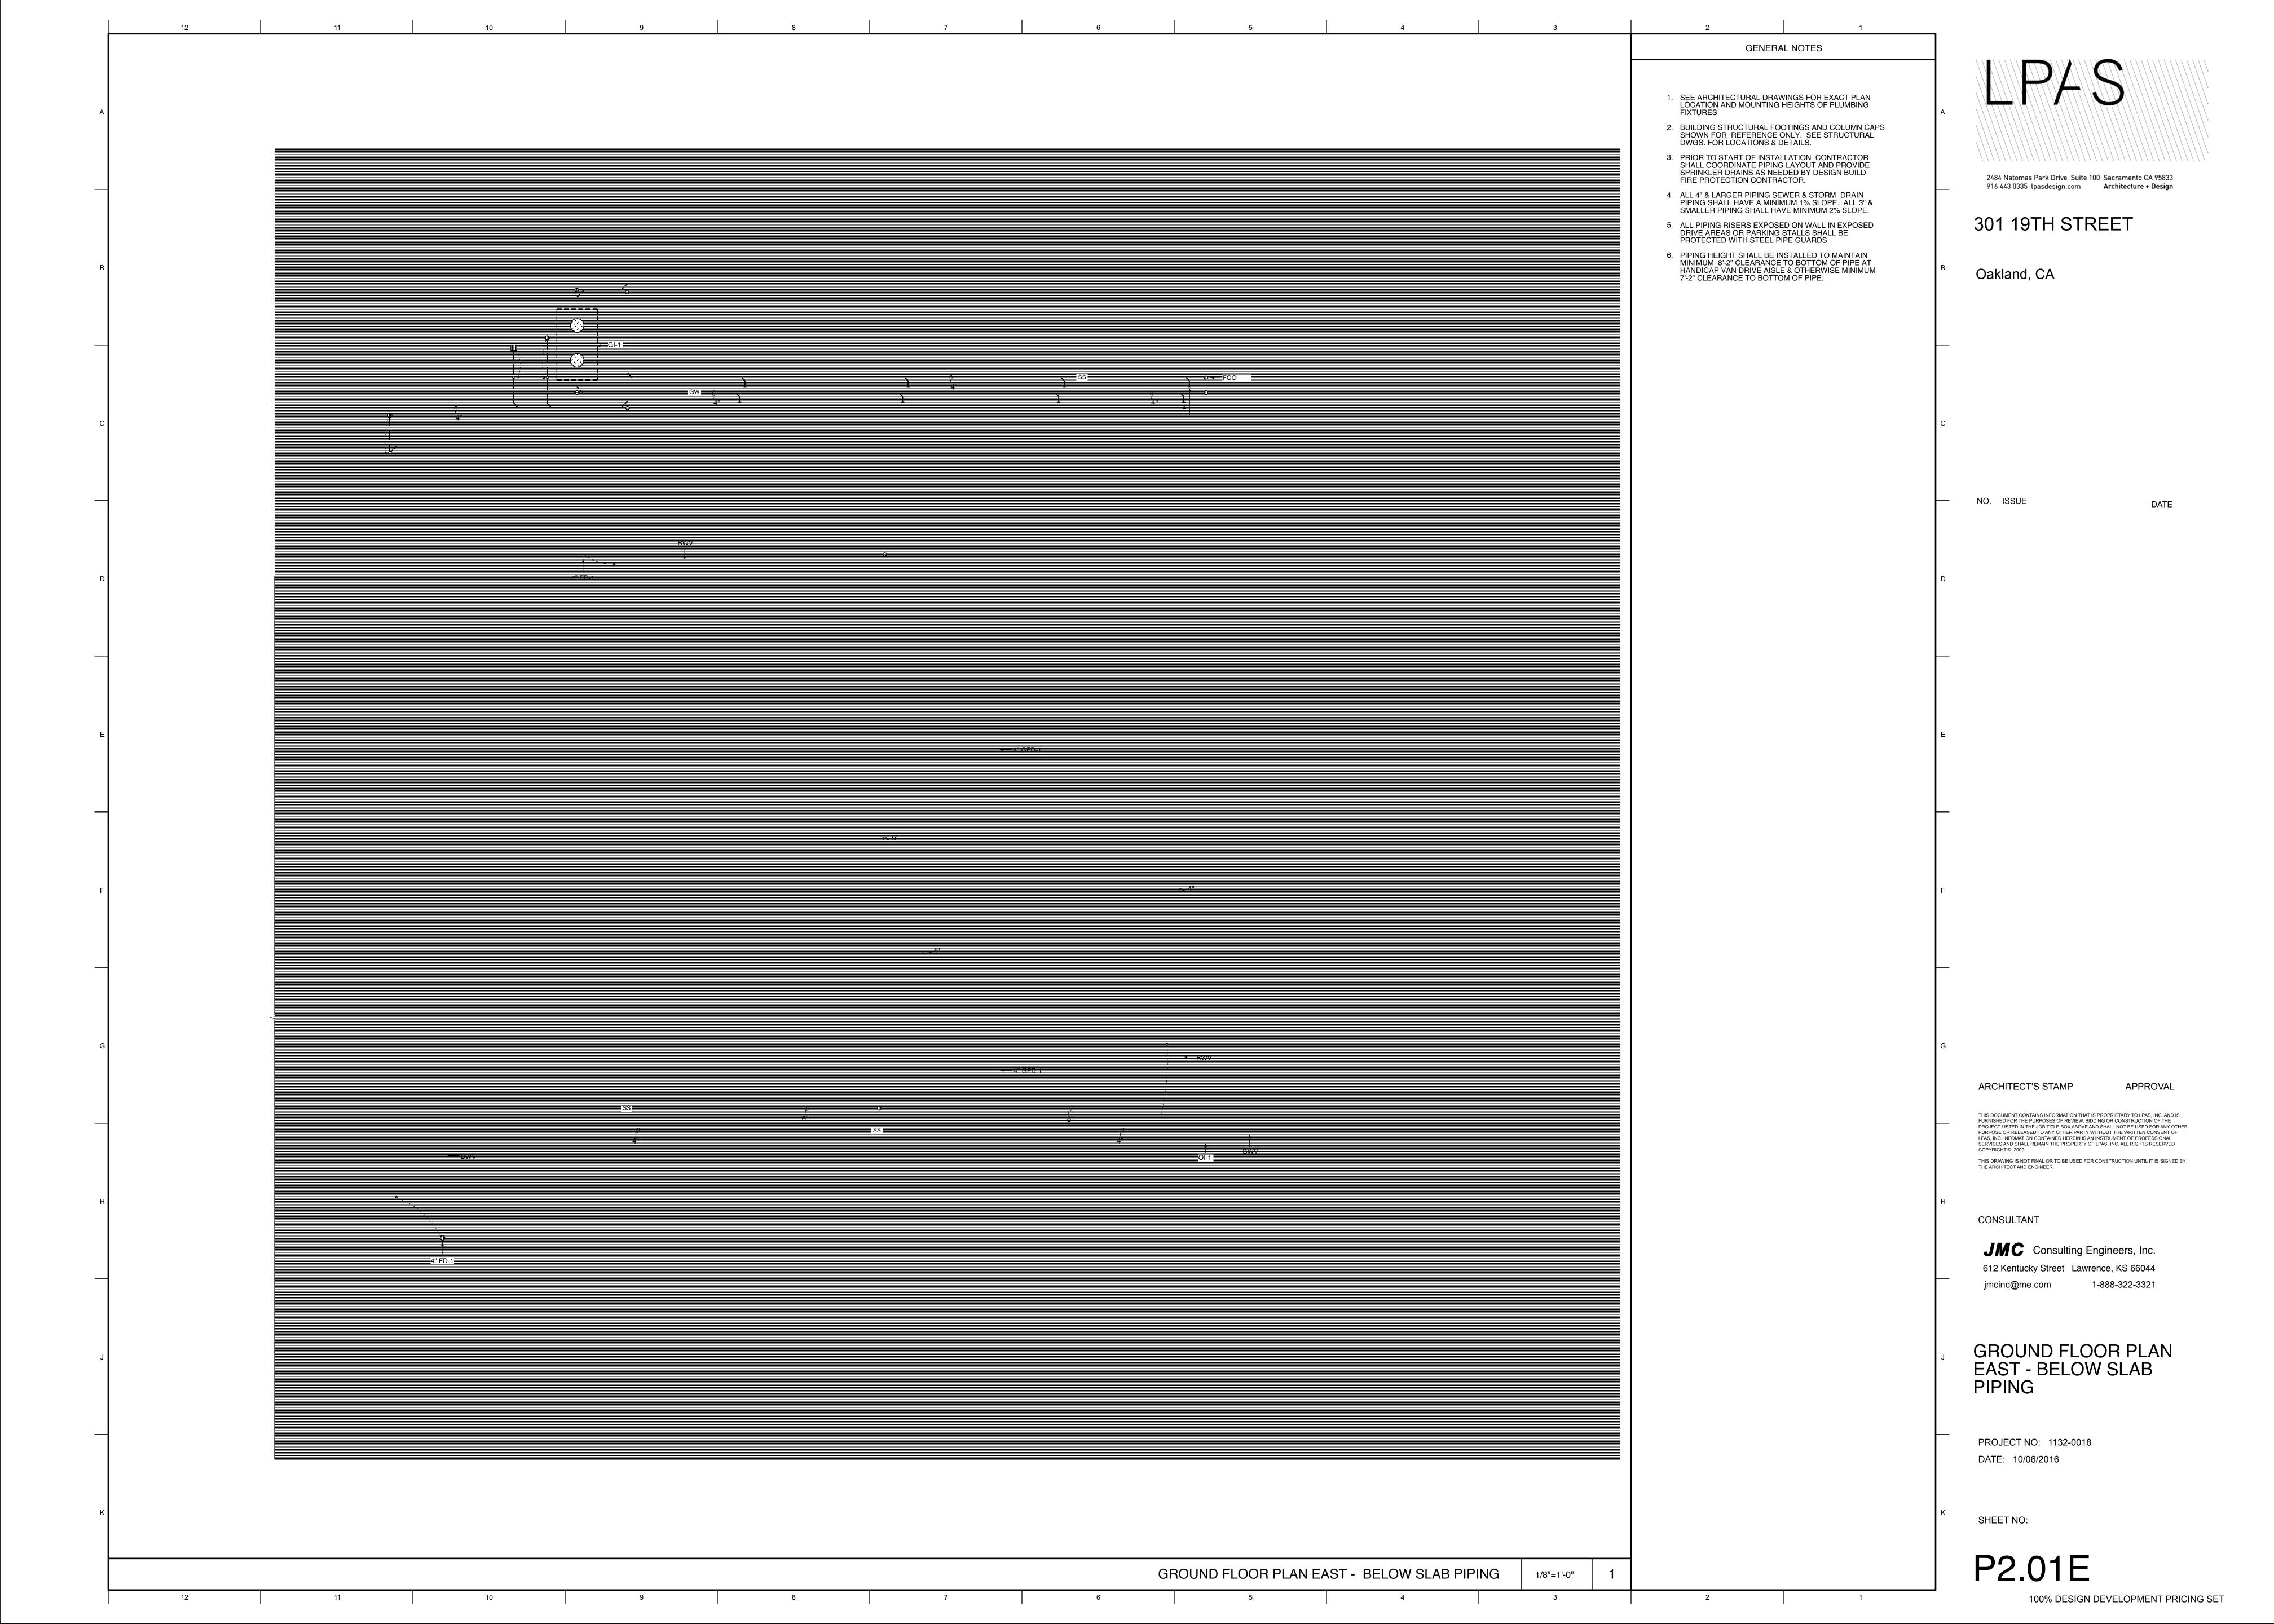

**GENERAL NOTES**  SEE ARCHITECTURAL DRAWINGS FOR EXACT PLAN LOCATION AND MOUNTING HEIGHTS OF PLUMBING FIXTURES BUILDING STRUCTURAL FOOTINGS AND COLUMN CAPS SHOWN FOR REFERENCE ONLY. SEE STRUCTURAL DWGS. FOR LOCATIONS & DETAILS. PRIOR TO START OF INSTALLATION CONTRACTOR SHALL COORDINATE PIPING LAYOUT AND PROVIDE SPRINKLER DRAINS AS NEEDED BY DESIGN BUILD FIRE PROTECTION CONTRACTOR. 2484 Natomas Park Drive Suite 100 Sacramento CA 95833 916 443 0335 lpasdesign.com Architecture + Design 4. ALL 4" & LARGER PIPING SEWER & STORM DRAIN PIPING SHALL HAVE A MINIMUM 1% SLOPE. ALL 3" & SMALLER PIPING SHALL HAVE MINIMUM 2% SLOPE. 301 19TH STREET ALL PIPING RISERS EXPOSED ON WALL IN EXPOSED DRIVE AREAS OR PARKING STALLS SHALL BE PROTECTED WITH STEEL PIPE GUARDS. PIPING HEIGHT SHALL BE INSTALLED TO MAINTAIN MINIMUM 8'-2" CLEARANCE TO BOTTOM OF PIPE AT HANDICAP VAN DRIVE AISLE & OTHERWISE MINIMUM 7'-2" CLEARANCE TO BOTTOM OF PIPE. Oakland, CA NO. ISSUE ARCHITECT'S STAMP APPROVAL THIS DOCUMENT CONTAINS INFORMATION THAT IS PROPRIETARY TO LPAS, INC. AND IS FURNISHED FOR THE PURPOSES OF REVIEW, BIDDING OR CONSTRUCTION OF THE PROJECT LISTED IN THE JOB TITLE BOX ABOVE AND SHALL NOT BE USED FOR ANY OTHER PURPOSE OR RELEASED TO ANY OTHER PARTY WITHOUT THE WRITTEN CONSENT OF LPAS, INC. INFOMATION CONTAINED HEREIN IS AN INSTRUMENT OF PROFESSIONAL SERVICES AND SHALL REMAIN THE PROPERTY OF LPAS, INC. ALL RIGHTS RESERVED COPPRIGHT © 2009 THIS DRAWING IS NOT FINAL OR TO BE USED FOR CONSTRUCTION UNTIL IT IS SIGNED BY THE ARCHITECT AND ENGINEER. CONSULTANT JMC Consulting Engineers, Inc. 612 Kentucky Street Lawrence, KS 66044 jmcinc@me.com 1-888-322-3321 GROUND FLOOR PLAN WEST - BELOW SLAB PIPING PROJECT NO: 1132-0018 DATE: 10/06/2016 SHEET NO: P2.01W GROUND FLOOR PLAN WEST - BELOW SLAB PIPING 1/8"=1'-0" 100% DESIGN DEVELOPMENT PRICING SET

